
# HARRY S TRUMAN COLLEGE: BIOLOGY LAB RENOVATION


# HARRY S TRUMAN COLLEGE 1145 WEST WILSON AVENUE, CHICAGO IL 60640 PROJECT NUMBER: 42280

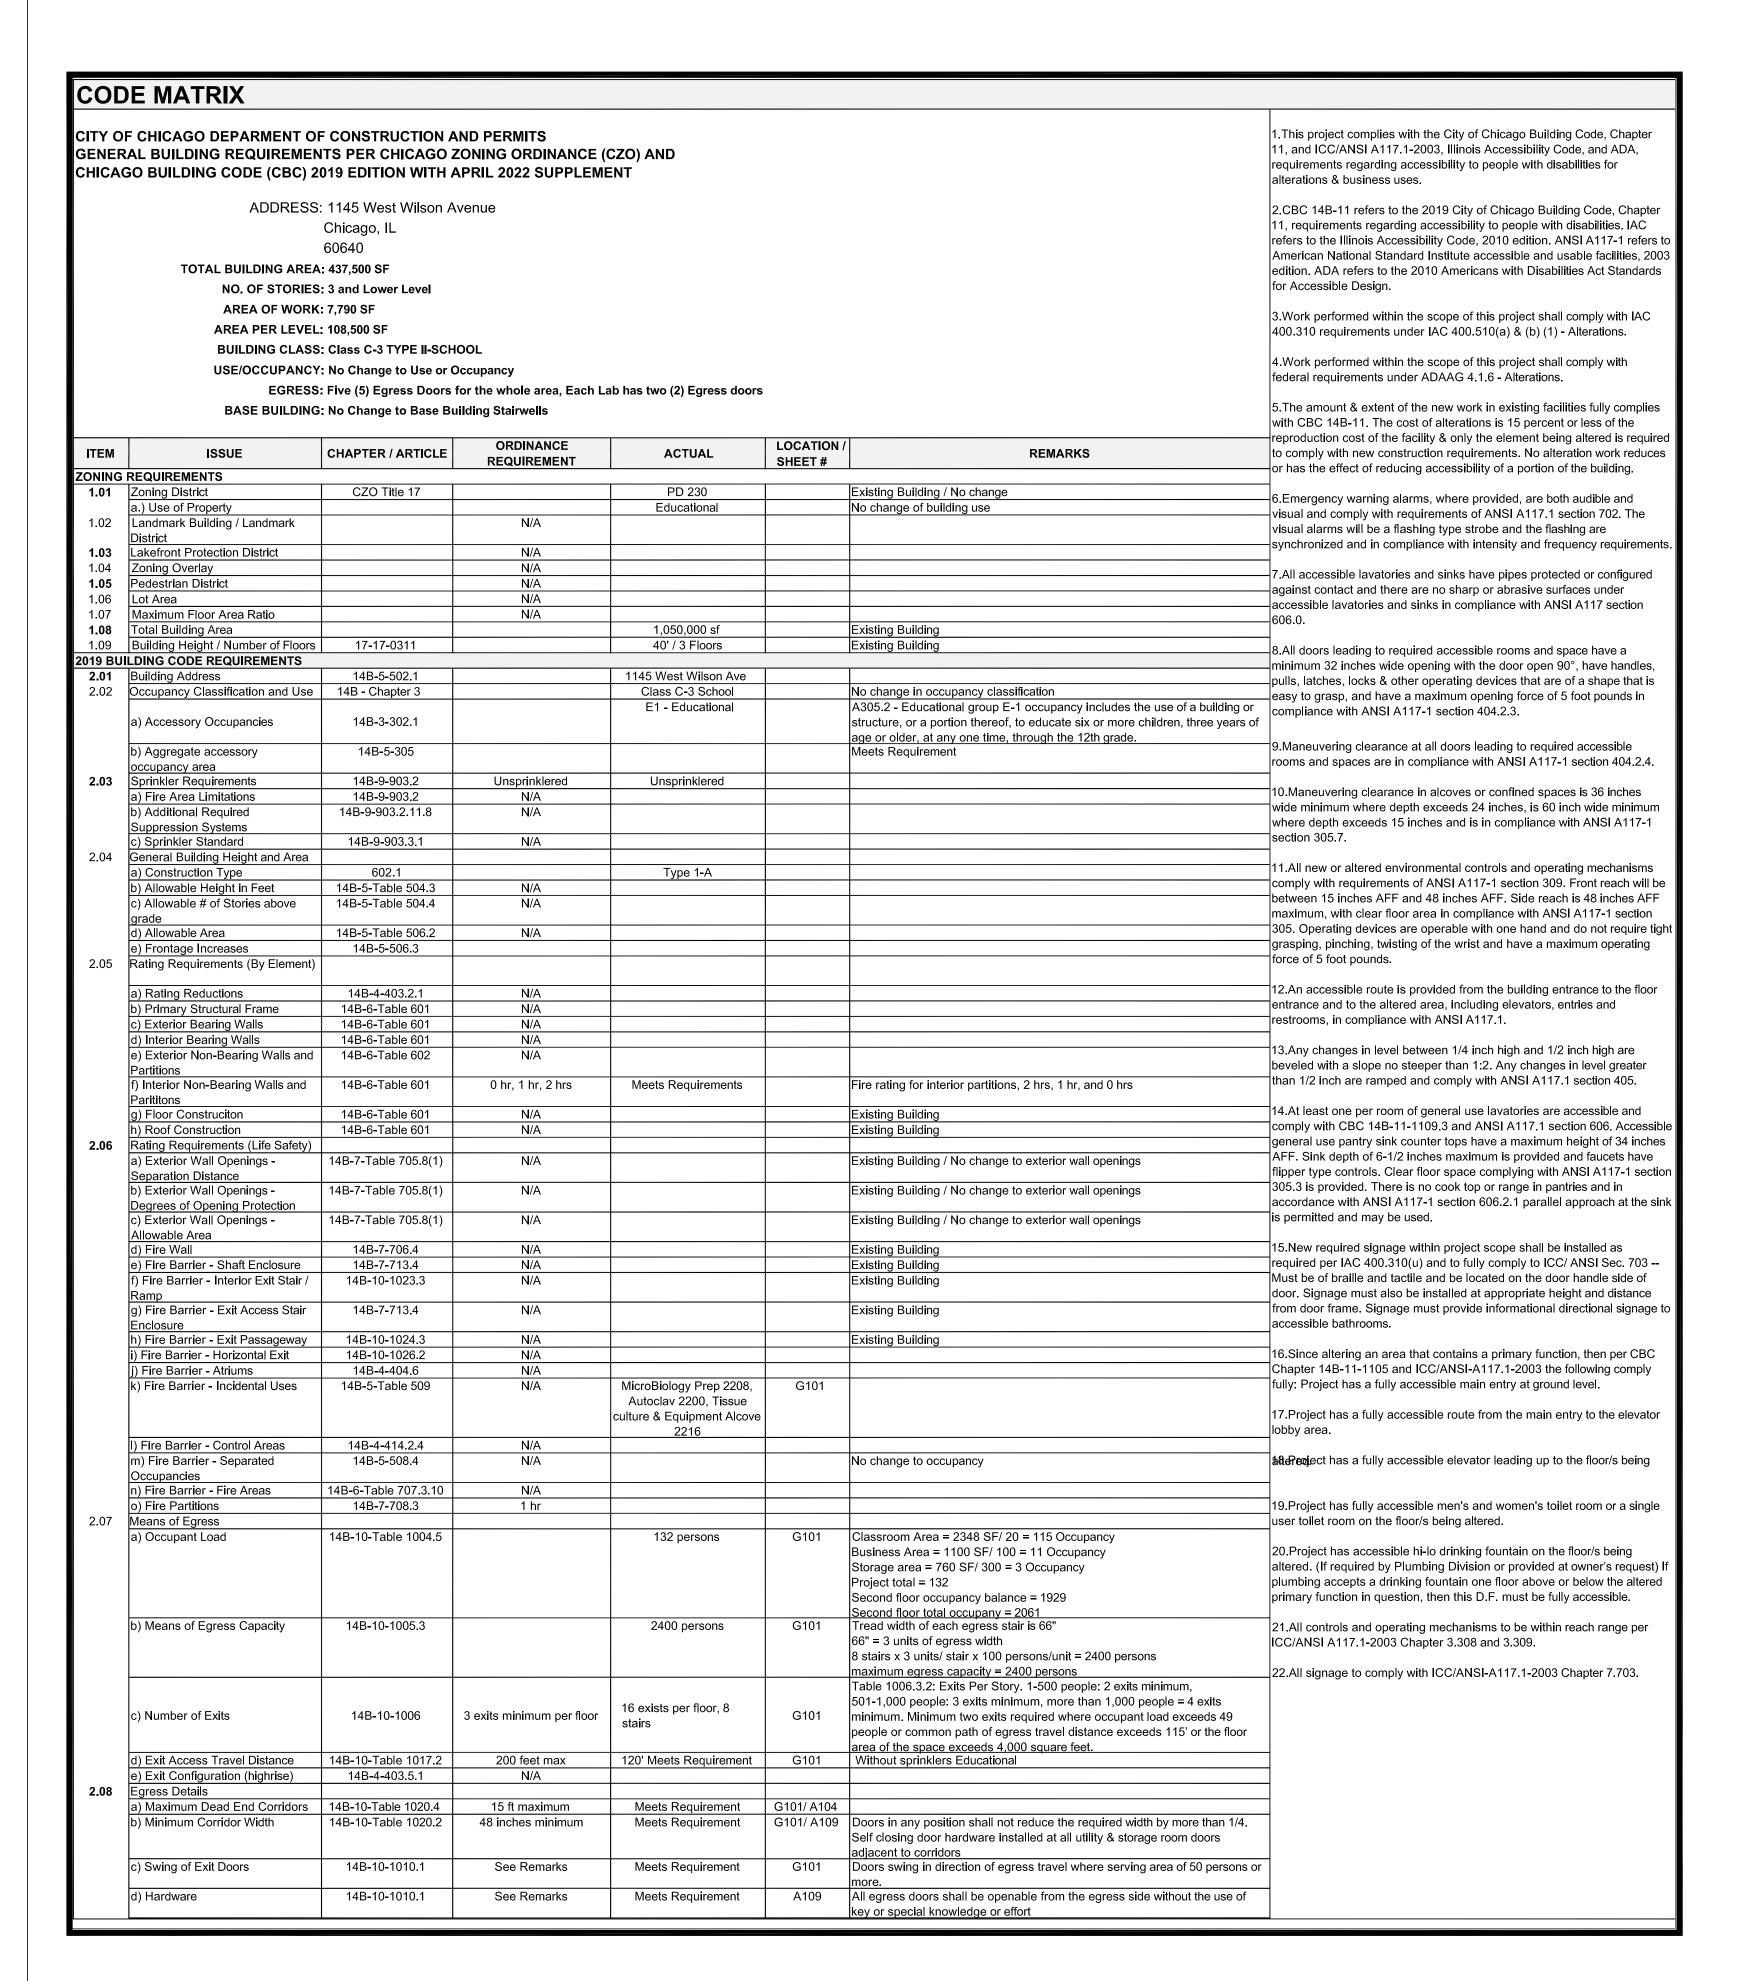


#### **BUILDING DATA** TOTAL BUILDING AREA: 437,500 SF NO. OF STORIES: 3 AND LOWER LEVEL AREA PER LEVEL: 108,500 SF ZONE: PD 120 **BUILDING CONSTRUCTION TYPE: I-A** CLASSIFICATION: CLASS C-3 TYPE II-SCHOOL UNSPRINKLERED

# PROJECT SUMMARY APPROXIMATELY 7,790 SF OF EXISTING INTERIOR CLASSROOM, OFFICE, AND BIOLOGY LAB SPACE BEING RENOVATED FOR SAME USE.

#### APPLICABLE CODES CONSTRUCTION CODE: CHICAGO BUILDING CODE MECHANICAL CODE: CHICAGO MECHANICAL CODE: CURRENT ADDITION ELECTRICAL CODE: CHICAGO ELECTRICAL CODE: CURRENT ADDITION ENERGY: ILLINOIS ENERGY CONSERVATION CODE: 2019 LIFE SAFETY: NFPA: 1997 ACCESSIBILITY: 2010 ILLINOIS ACCESSIBILITY CODE, 2010 ADAGG, CHICAGO CODE CHAPTER 18.

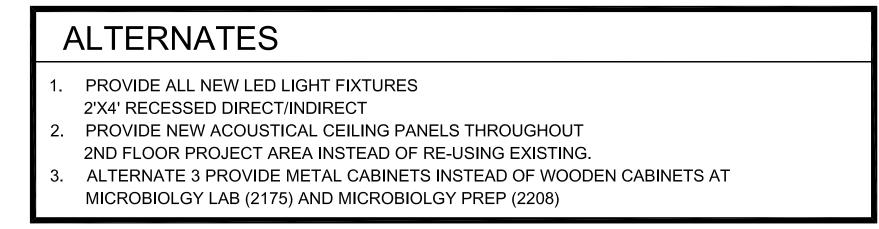

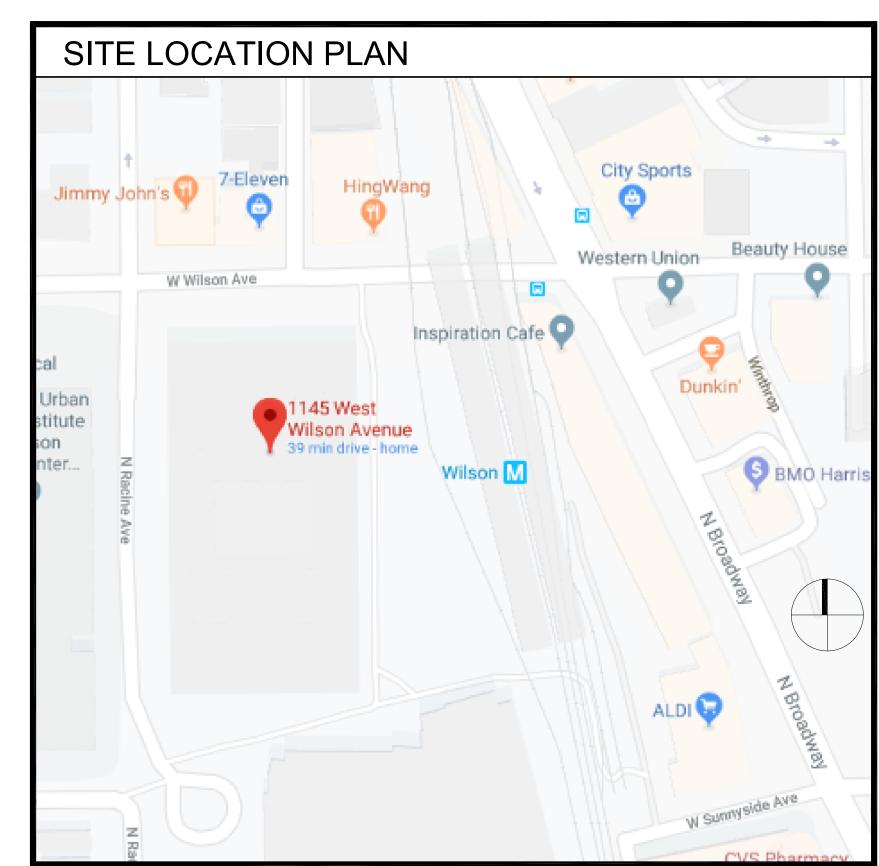

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LF3-2	LAB FURNISHINGS ELEVATIONS	•	•	
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M1-1	MECHANICAL SECOND FLOOR DEMOLITION PLAN	•	•	
M2-1 M2-2	MECHANICAL SECOND FLOOR NEW WORK PLAN MECHANICAL ROOF PLAN	•	•	
M5-1	MECHANICAL ROOF PLAN MECHANICAL SCHEDULES	•	•	
M6-1	MECHANICAL DETAILS	•	•	
M6-2	MECHANICAL DETAILS	•	•	
MP2-1	MECHANICAL DETAILS	•	•	
MP2-2	MECHANICAL DETAILS	•	•	
ELECTRI				
E0-1	ELECTRICAL SYMBOLS, NOTES, AND ABBREVIATIONS	•	•	
E1-1	ELECTRICAL SECOND FLOOR LICHTING DEMO DI ANI	•	•	
E1-2 E1-2ALT	ELECTRICAL SECOND FLOOR LIGHTING DEMO PLAN ALTERNATE ELECTRICAL SECOND FLOOR LIGHTING DEMO PLAN	•	•	
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E2-1	ELECTRICAL SECOND FLOOR NEW WORK PLAN	•	•	
E2-2	ELECTRICAL SECOND FLOOR CEILING LIGHTING NEW WORK PLAN		•	
E2-2ALT	ALTERNATE ELECTRICAL SECOND FLOOR CEILING LIGHTING NEW WORK PLAN	•	•	
E2-3	ELECTRICAL SECOND FLOOR UNDER CABINET LIGHTING NEW			
	WORK PLAN		•	
E3-1	ELECTRICAL SOLIEDIU ES	•	•	
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L4-Z	LELOTINO/AL CONLEGUELO & DETAILO		<u> </u>	
PLUMBIN		,		
P0-1	PLUMBING SYMBOLS, ABBREVIATIONS AND NOTES	•	•	
P1-0	PLUMBING FIRST FLOOR CEILING DEMOLITION PLAN PLUMBING SECOND FLOOR DEMOLITION PLAN	•	•	
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P2-2	PLUMBING SECOND FLOOR CEILING PLAN	•	•	
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P4-1	PLUMBING RISER DIAGRAMS	•	•	

07/25/23 ISSUE FOR BID 05/17/23 ISSUE FOR 50% CD 04/28/23 ISSUE FOR CLIENT REVIEW NO. DATE REVISIONS/ISSUANCES CITY COLLEGES OF CHICAGO -TRUMAN COLLEGE PROJECT NUMBER 42280 PROJECT MANAGER: ARCH/ENG: SCALE: DRAWN BY: **CHECKED BY:** 

TITLE SHEET

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Environmental Engineer MEPFP Engineer Environmental Design International, Inc. 33 E Monroe Street #1825 Chicago, IL 60603 312.345.1400

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Architect of Record Tilton Kelly + Bell, LLC 55 West Monroe - Suite 1975 Chicago, IL 60603 312.447.3100 www.tiltonkellybell.com

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1145 W Wilson Ave,


Chicago, IL 60604


(773) 907-4000

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# SYMBOLS AND ABBREVIATIONS




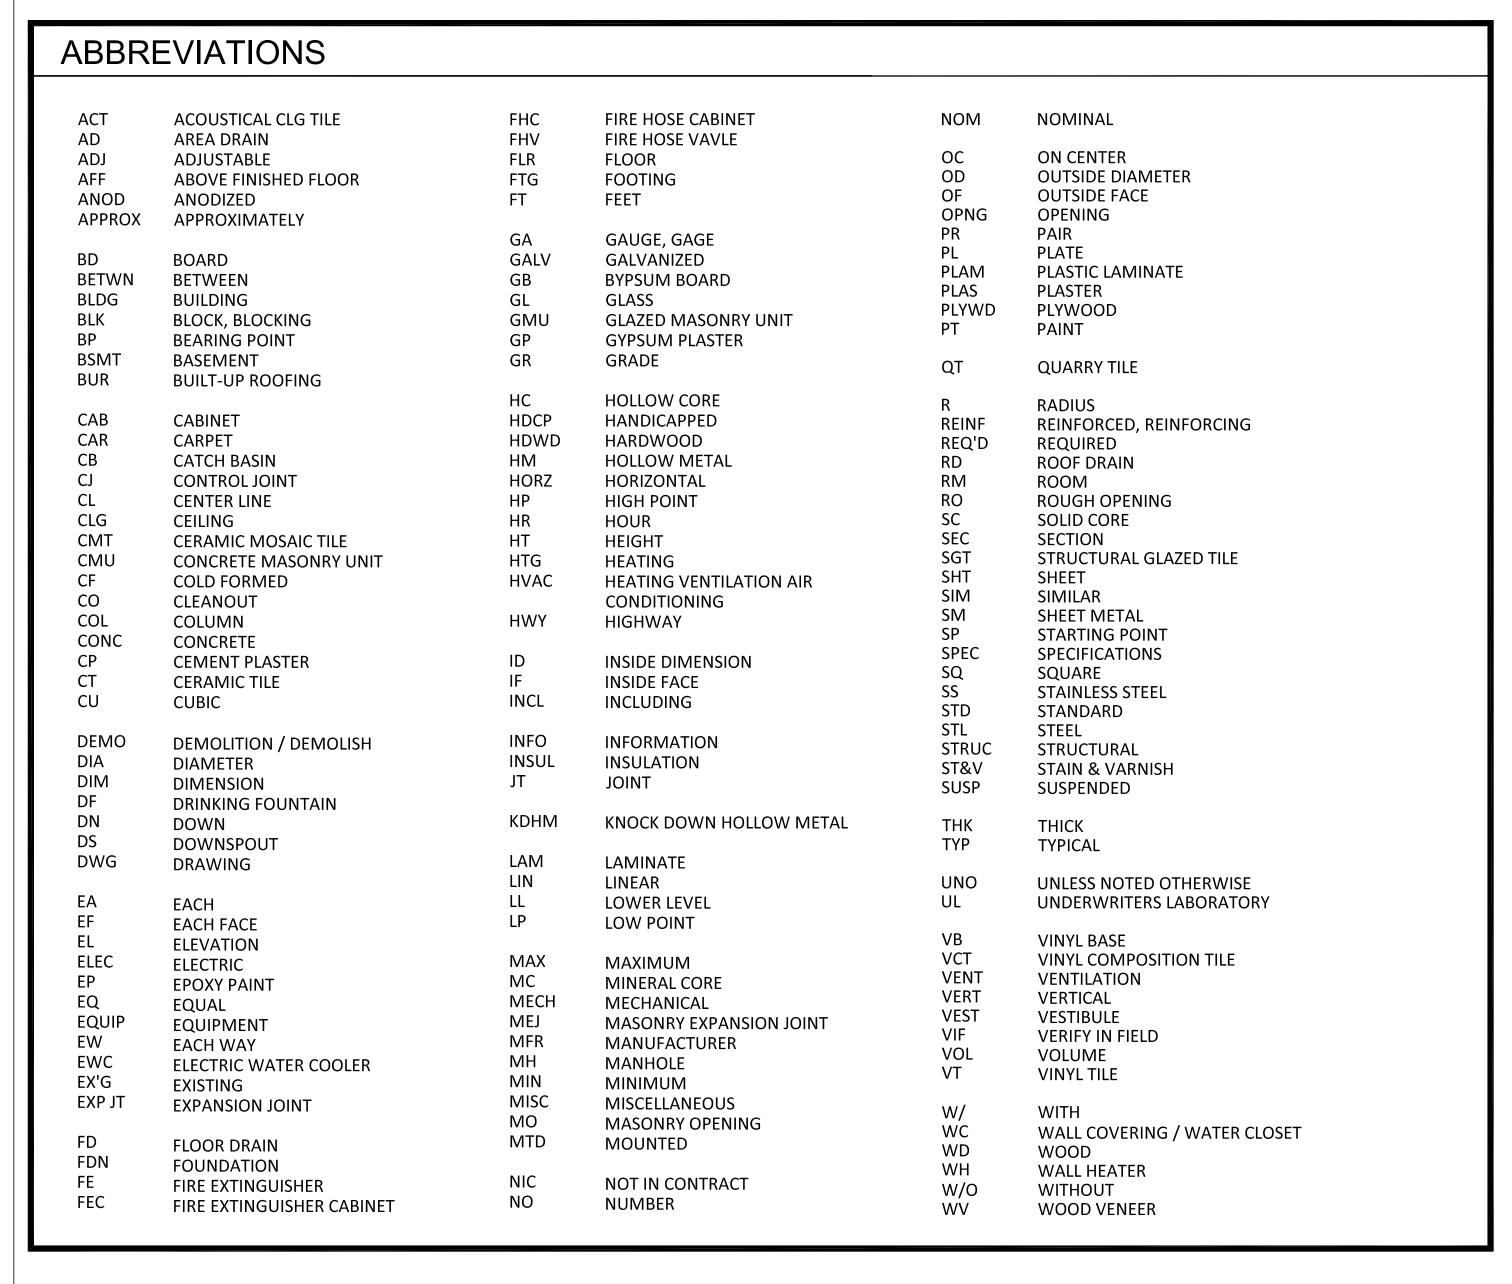

#### PROJECT GENERAL NOTES

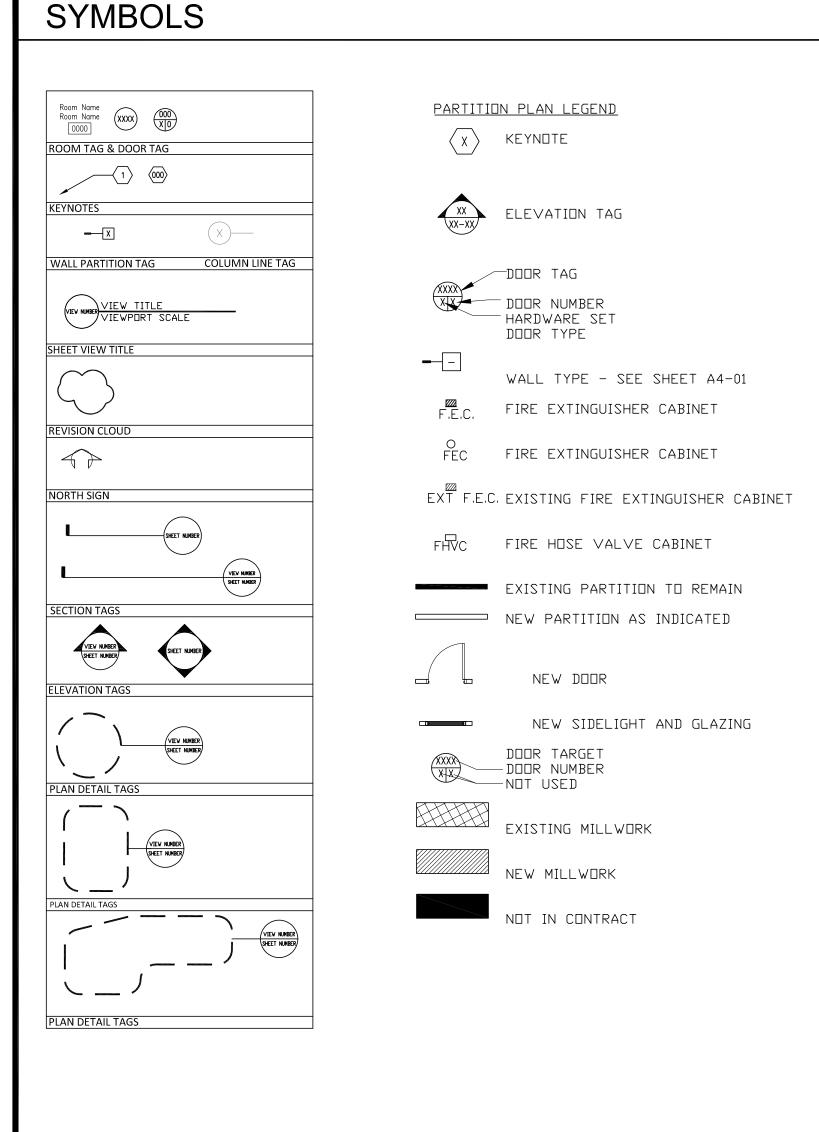- .. THE WORK SHALL COMPLY WITH THE APPLICABLE BUILDING CODE AND OTHER APPLICABLE CODES, ORDINANCES AND REGULATIONS LISTED IN THE DRAWINGS AND SPECIFICATIONS AND REQUIRED BY LOCAL BUILDING AUTHORITIES. THE GOVERNING RULES, REGULATIONS AND ORDINANCES ARE COLLECTIVELY REFERRED TO AS 'THE CODE'. THE CONTRACTOR SHALL REPORT ANY INCONSISTENCIES, CONFLICTS OR OMISSIONS DISCOVERED PRIOR TO PERFORMING THE WORK.
- . THE GENERAL CONTRACTOR SHALL COORDNATE WITH THE OWNER TO DETERMINE THE RULES RELATIVE TO CONSTRUCTION, HOW AND WHEN DELIVERIES ARE MADE, WHAT TASKS AND TYPES OF WORK MAY BE DONE DURING REGULAR OR OVERTIME BASIS, AND IN GENERAL ANY SPECIFIC BUILDING REQUIREMENTS.
- . THE GENERAL CONTRACTOR SHALL BE RESPONSIBLE FOR THE SUBCONTRACTORS' RECEIPT OF THE PROJECT DOCUMENTS AS WELL AS ALL FUTURE ADDENDA, BULLETINS, FIELD DIRECTIVES, AND CHANGE ORDERS.
- I. THE CONTRACTOR SHALL COORDINATE WITH THE OWNER THE STORAGE OF MATERIALS AND SHALL PROVIDE SECURE PROTECTION TO PREVENT VANDALISM AND LOSS OF MATERIALS BY THEFT OR DAMAGE.
- 5. WHERE ADJACENT AREAS BEYOND THE IMMEDIATE CONSTRUCTION AREA WILL BE OCCUPIED DURING THE CONSTRUCTION PERIOD, THE CONTRACTOR SHALL:
  - A.CONFORM TO OWNER'S REQUIREMENTS FOR HOURS OF CONSTRUCTION OPERATIONS, ACCESS TO BUILDING SPACES, AND ALLOWABLE LEVELS OF NOISE DURING BUSINESS
  - B. CONSTRUCTION OPERATIONS SHALL NOT BLOCK HALLWAYS, ACCESSIBLE ROUTES, OR MEANS OF EGRESS.
  - C. CONSTRUCTION OPERATIONS SHALL NOT CAUSE INTERRUPTION OF ELECTRICAL PLUMBING OR HVAC SERVICE TO THE BUILDING WITHOUT PRIOR NOTIFICATIONS AND APPROVALS.
  - D. PROPERLY PROTECT ALL PUBLIC AREAS SUBJECT TO CONSTRUCTION TRAFFIC.
- E. ERECT AND MAINTAIN TEMPORARY BRACING, LIGHTS, DUSTPROOF PARTITIONS, BARRICADES, AND WARNING SIGNS AS NECESSARY TO PREVENT INJURY, NOISE, DUST AND INCONVENIENCE, AND TO PREVENT DAMAGE TO ADJACENT CONSTRUCTION WHICH IS TO REMAIN IN PLACE.
- F. IF PERMANENTLY INSTALLED AIR HANDLERS ARE USED DURING CONSTRUCTION FILTRATION MEDIA WITH A MINIMUM EFFICIENCY REPORTING VALUE OF (MERV 8) MUST BE USED AT EACH RETURN AIR GRILLE.
- . THE CONTRACTOR IS SOLELY RESPONSIBLE FOR THE PROVISION AND MAINTENANCE OF ALL BRACING, SHORING, ENCLOSURES, BARRIERS AND SCAFFOLDING REQUIRED TO PROVIDE SAFE WORKING ENVIRONMENT AS DICTATED BY SITE CONDITIONS AND THE PROGRESSION OF
- 7. THE CONTRACTOR SHALL PROTECT THE PROPERTY OF THE OWNER INCLUDING, BUT NOT LIMITED TO, WINDOWS, DOORS, FLOORS, WALLS, CEILINGS, STAIRS, ELEVATORS, TOILET FACILITIES, AND ELECTRICAL, PLUMBING AND HVAC EQUIPMENT. DAMAGE CAUSED BY THE CONSTRUCTION WORK OR WORKERS MUST BE MADE GOOD IN A TIMELY FASHION. THE GENERAL CONTRACTOR SHALL BE FULLY RESPONSIBLE FOR ALL SUB-CONTRACTORS.
- 3. THE CONTRACTOR SHALL PERFORM DAILY CLEANING OF THE JOB SITE DURING THE CONSTRCUTION PERIOD AND SHALL PROTECT FINISHED WORK FROM DAMAGE.
- 9. THE CONTRACTOR SHALL BE RESPONSIBLE FOR AL COSTS RELATED TO THE TRANSPORT AND HOISTING OF MATERIALS AND EQUIPMENT AND SHALL BE RESPONSIBLE FOR ALL UNLOADING, CHECKING AND STORAGE OF SAME IN CONNECTION WITH THE CONSTRCUTION WORK.
- 0. THE CONTRACTOR SHALL MAKE ARRANGEMENTS FOR, MAINTAIN AND PAY ALL COSTS FOR TEMPORARY WATER, PLUMBING, POWER, LIGHTING, HEATING AND VENTILATION REQUIRED TO PROPERLY CONDUCT THE WORK.
- .1. DO NOT SCALE THE DRAWINGS. WRITTEN DIMENSIONS SHALL GOVERN. SHOULD DIMENSIONAL DISCREPANCIES BE ENCOUNTERED, CLARIFICATIONS SHALL BE OBTAINED FROM
- .2. LARGE SCALE DETAILS SHALL TAKE PRECEDENCE OVER SMALLER SCALE PLANS AND
- 13. INSTALL ALL EQUIPMENT AND MATERIALS ACCORDING TO MANUFACTURER'S RECOMMENDATIONS. DIFFICULTIES ARE TO BE REPORTED TO THE ARCHITECT IMMEDIATELY.
- 14. THE OWNER, ARCHITECT, CONSULTANTS AND INSPECTORS SHALL BE PERMITTED ACCESS TO THE SITE AT ALL TIMES DURING NORMAL WORKING HOURS. .5. DETAILS ARE INTENDED TO INDICATE THE INTENT OF THE DESIGN. MINOR MODIFICATINS
- MAY BE REQUIRED TO SUIT FIELD CONDITINS. SUCH MODIFICATIONS SHALL BE INCLUDED AS PART OF THE WORK.
- .6. ALL WORK SHALL BE EXECUTED IN A WORKMANLIKE MANNER BY MECHANICS AND TRADESPERSONS SKILLED IN THEIR RERSPECTIVE TRADES AND IN ACCORDANCE WITH BEST TRADE PRACTICES.
- .7. REVIEW OF SUBMITTALS SHALL NOT RELIEVE THE CONTRACTOR OF OBLIGATIONS OR RESPONSIBILITIES FOR DEVIATIONS FROM THE REQUIREMENTS OF THE CONTRACT DOCUMENTS UNLESS THE ARCHITECT IS NOTIFIED AND SPECIFICALLY APPROVES OF ANY DEVIATIONS AT THE TIME OF SUBMISSION.
- .8. REVIEW OF SUBMITTALS SHALL NOT RELIEVE THE CONTRACTOR'S OBLIGATION FOR COORDINATION NOR WAIVE REPSONSIBILITY FOR ERRORS AND OMISSIONS IN SUBMITTALS, INCLUDING FIELD MEASUREMENTS.
- .9. THE PRESENCE OF A REPRESENTATIVE OF THE ARCHITECT ON THE JOB SITE DOES NOT IMPLY CONCURRENCE WITH OR APPROVAL OF ANY WORK. THE CONTRACTOR SHALL CALL TO THE ATTENTION OF THE ARCHITECT, IN WRITING, ALL SPECIFIC ITEMS FOR WHICH THE ARCHITECT'S REVIEW IS REQUIRED.
- 20. UPON SUBSTANTIAL COMPLETION OF THE WORK, THE CONTRACTOR SHALL PREPARE A "PUNCHLILST" OF CORRECTIONS AND UNSATISFACTORY AND/OR INCOMPLETE WORK FOR REVIEW BY THE ARCHITECT.
- 21. THE CONTRACTOR SHALL MAINTAIN ON-SITE AT ALL TIMES ONE RECORD COPY OF ALL DRAWINGS, PERMITS, SUBMITTALS AND SAMPLES ON WHICH TO RECORD CHANGES DURING CONSTRUCTION. ACCES TO THESE SHALL BE PROVIDED FOR THE USE OF ALL TRADES, OWNER REPRESENTATIVES, AND THE ARCHITECT DURING THE CONSTRUCTION.
- 22. THE CONTRACTOR SHALL IMMEDIATELY NOTIFY THE OWNER IN THE EVENT THAT MOLD OR ASBESTOS IS UNCOVERED. THE OWNER SHALL RETAIN A QUALIFIED CONSULTANT WHO SHALL ARRANGE FOR PROMPT IDENTIFICATION, TESTING, TREATMENT, REMEDIATION, AND DISPOSAL OF THE MOLD OR ASBESTOS.

07/25/23 ISSUE FOR BID 05/17/23 ISSUE FOR 50% CD 04/28/23 ISSUE FOR CLIENT NO. DATE REVISIONS/ISSUANCES

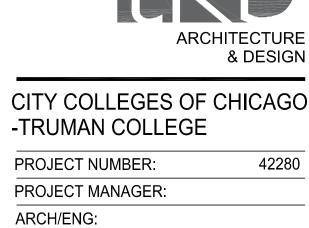

SYMBOLS AND **ABBREVIATIONS** 

SCALE:

DRAWN BY:

CHECKED BY:

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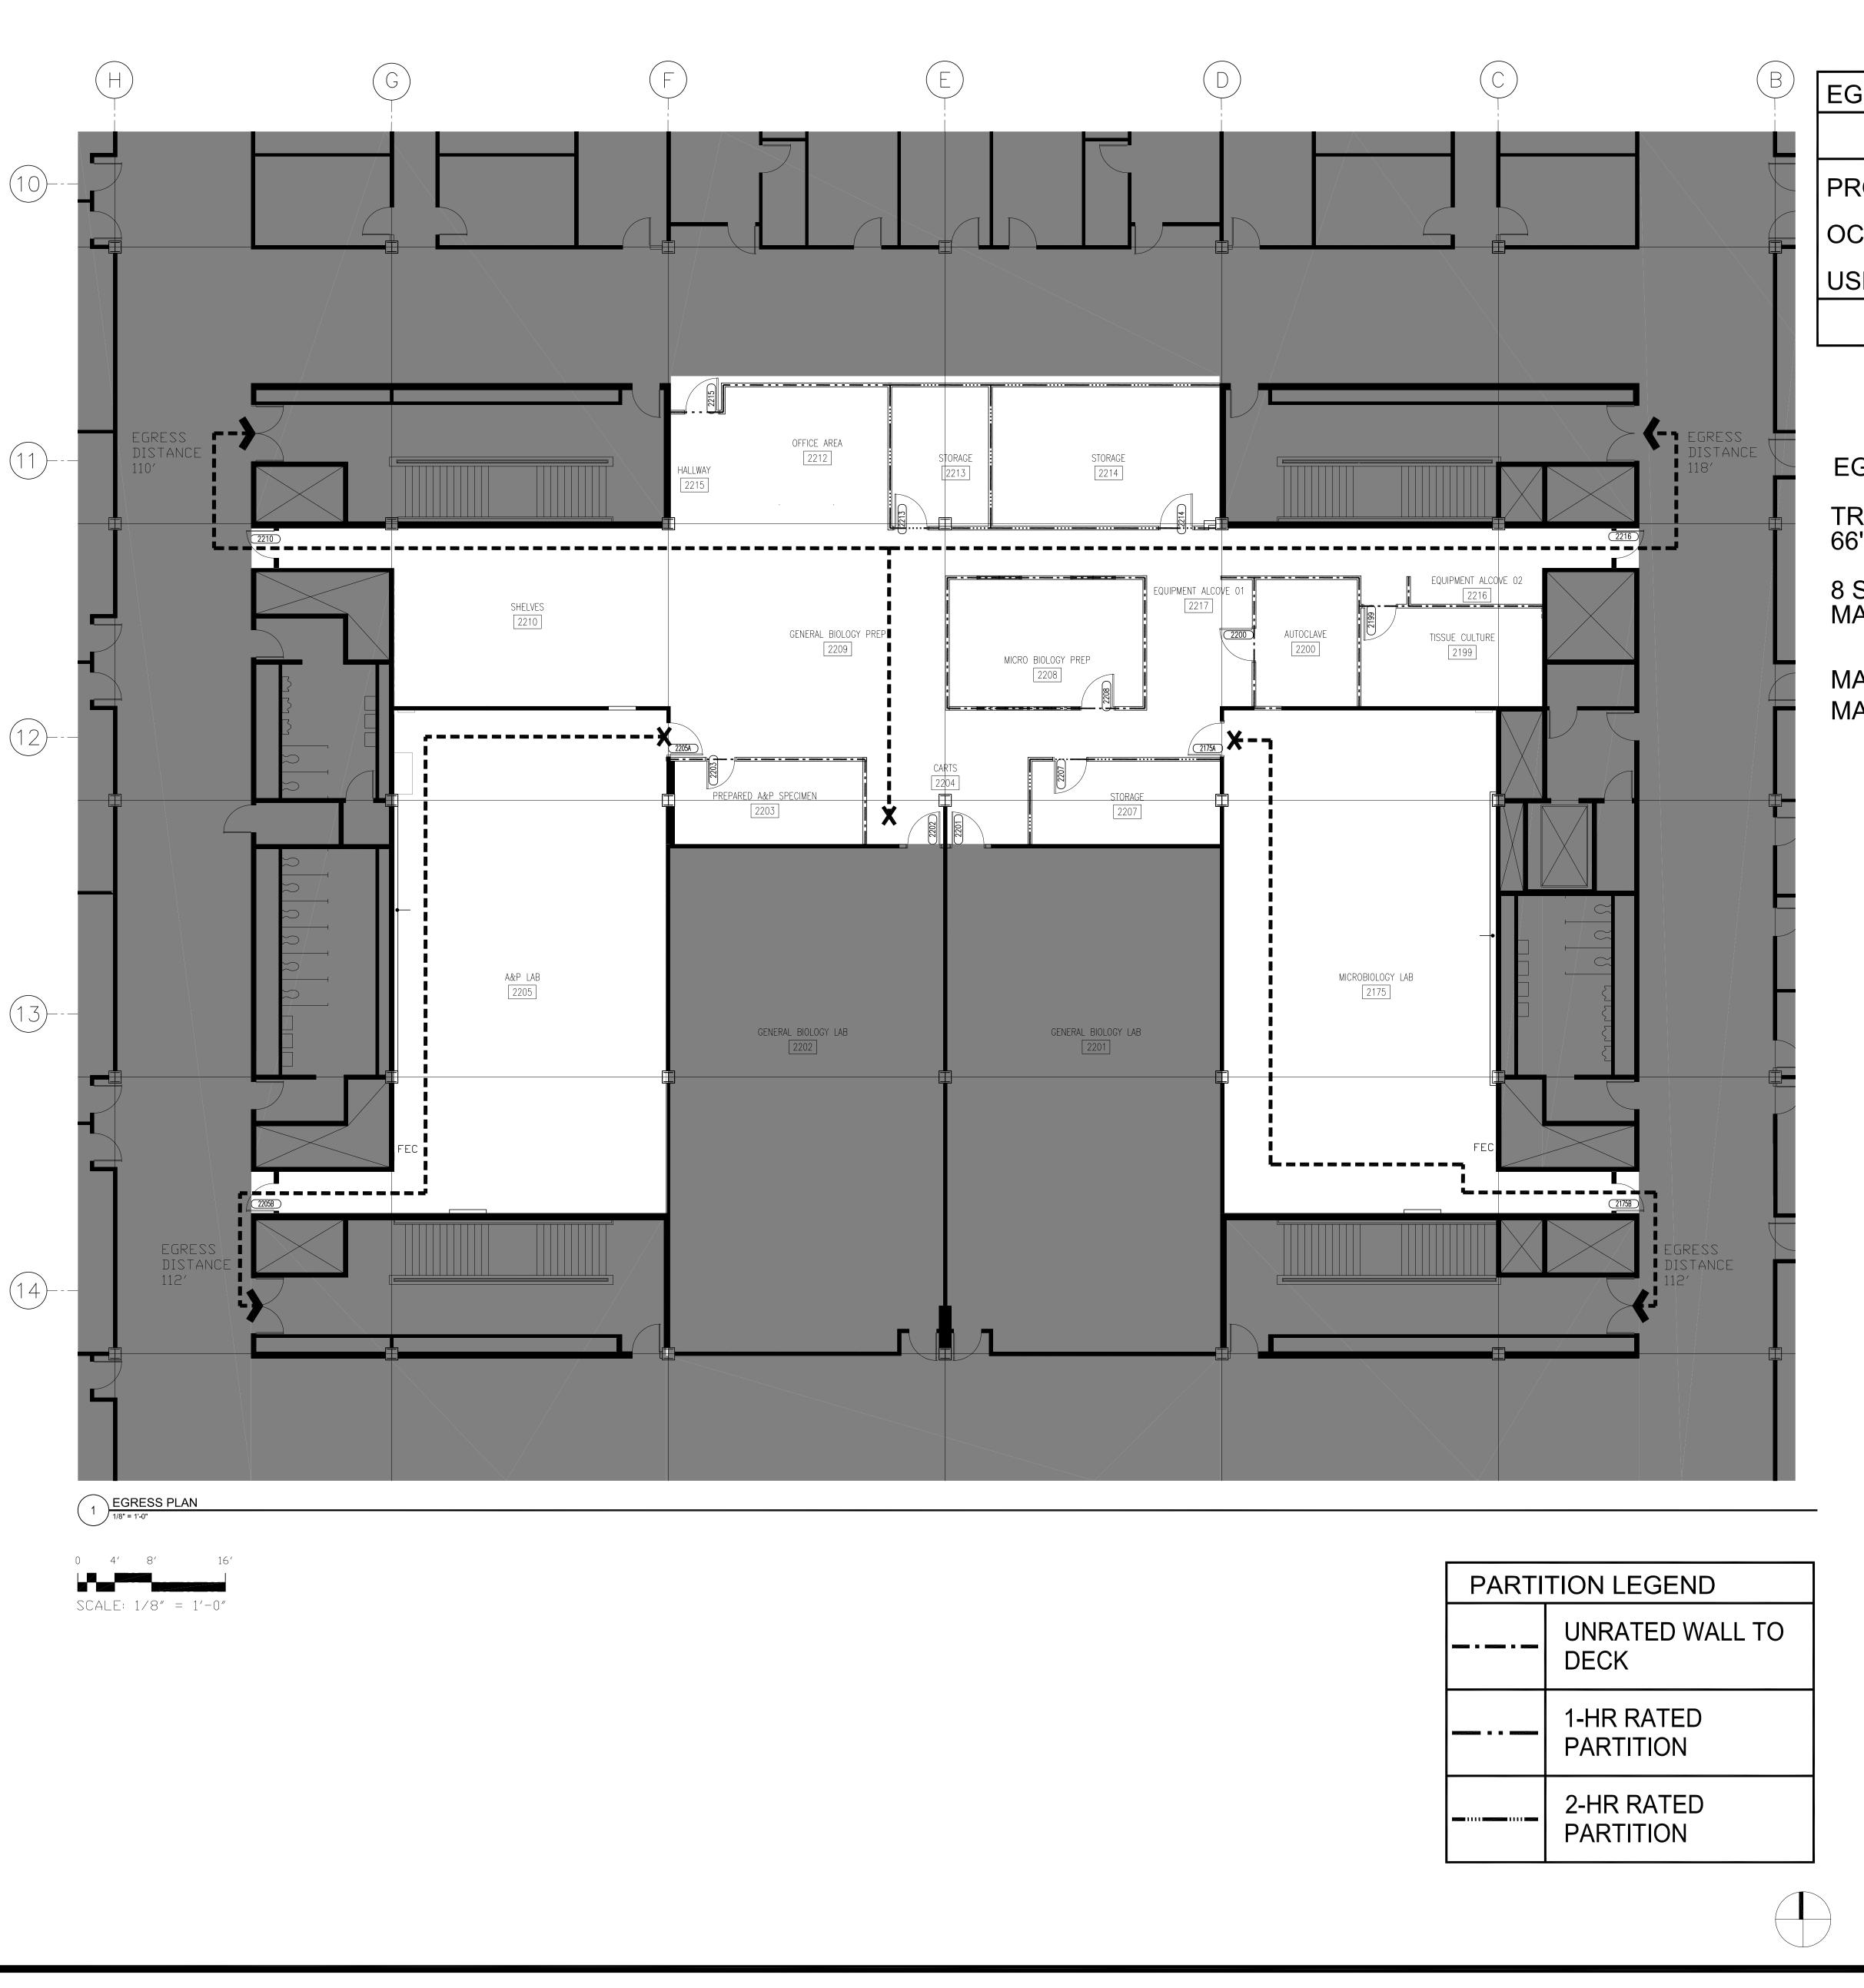
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www.envdesigni.com

312.345.1400

Architect of Record

Owner



EGRESS ANALYSIS							
	TYPE	AREA (SF)	SF/OCCUP.	OCCUP.			
PROJECT	CLASSROOM	2348	20	118			
OCCUPANCY	BUSINESS	1100	100	11			
USE AREAS	STORAGE	760	300	3			
			PROJECT TOTAL	132			

2ND FLOOR OCCUPANT BALANCE: 1929 TOTAL 2ND FLOOR OCCUPANTS: 2061

EGRESS CAPACITY

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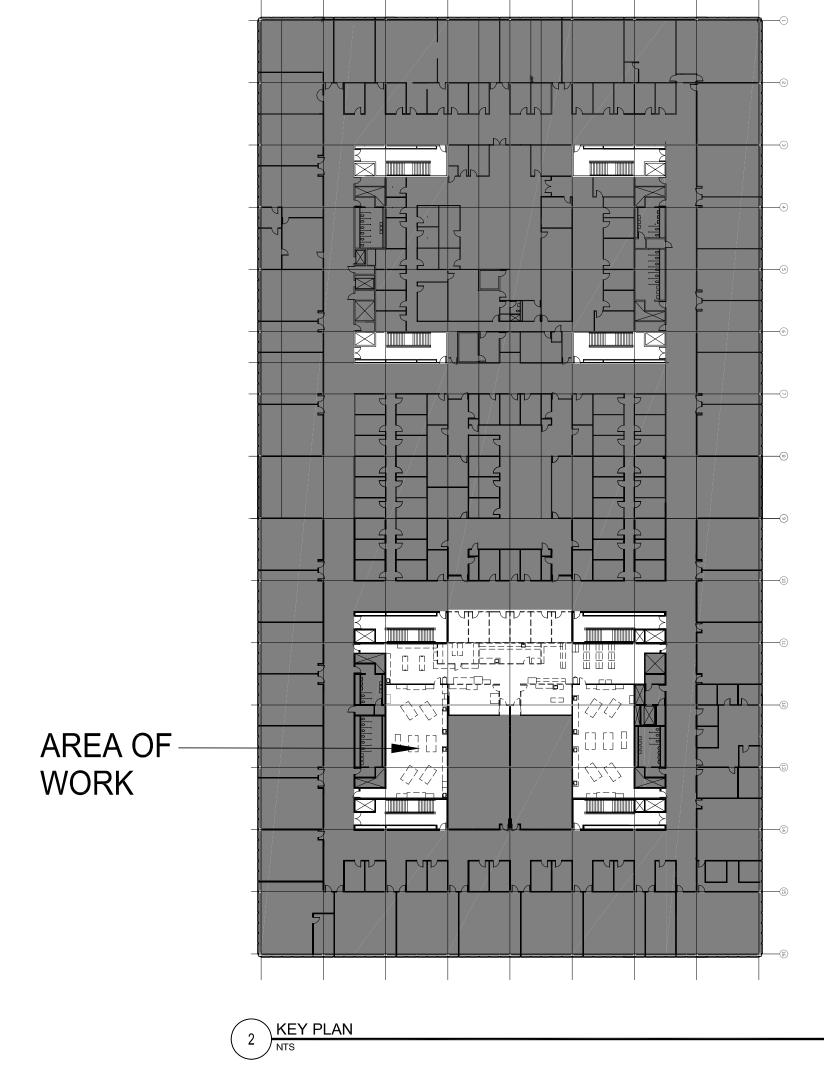
Chicago, IL 60604 (773) 907-4000

www.ccc.edu

TREAD WIDTH OF EACH EGRESS STAIR IS 66" 66" = 3UNITS OF EGRESS WIDTH

8 STAIRS X 3 UNITS/ STAIR X 100 PERSONS/UNIT = 2400 PERSONS MAXIMUM EGRESS CAPACITY = 2400 PERSONS

MAXIMUM ALLOWANCE TRAVEL DISTANCE = 200 FT MAXIMUM TRAVEL DISTANCE = 120 FT



PLAN

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CITY COLLEGES of CHICAGO

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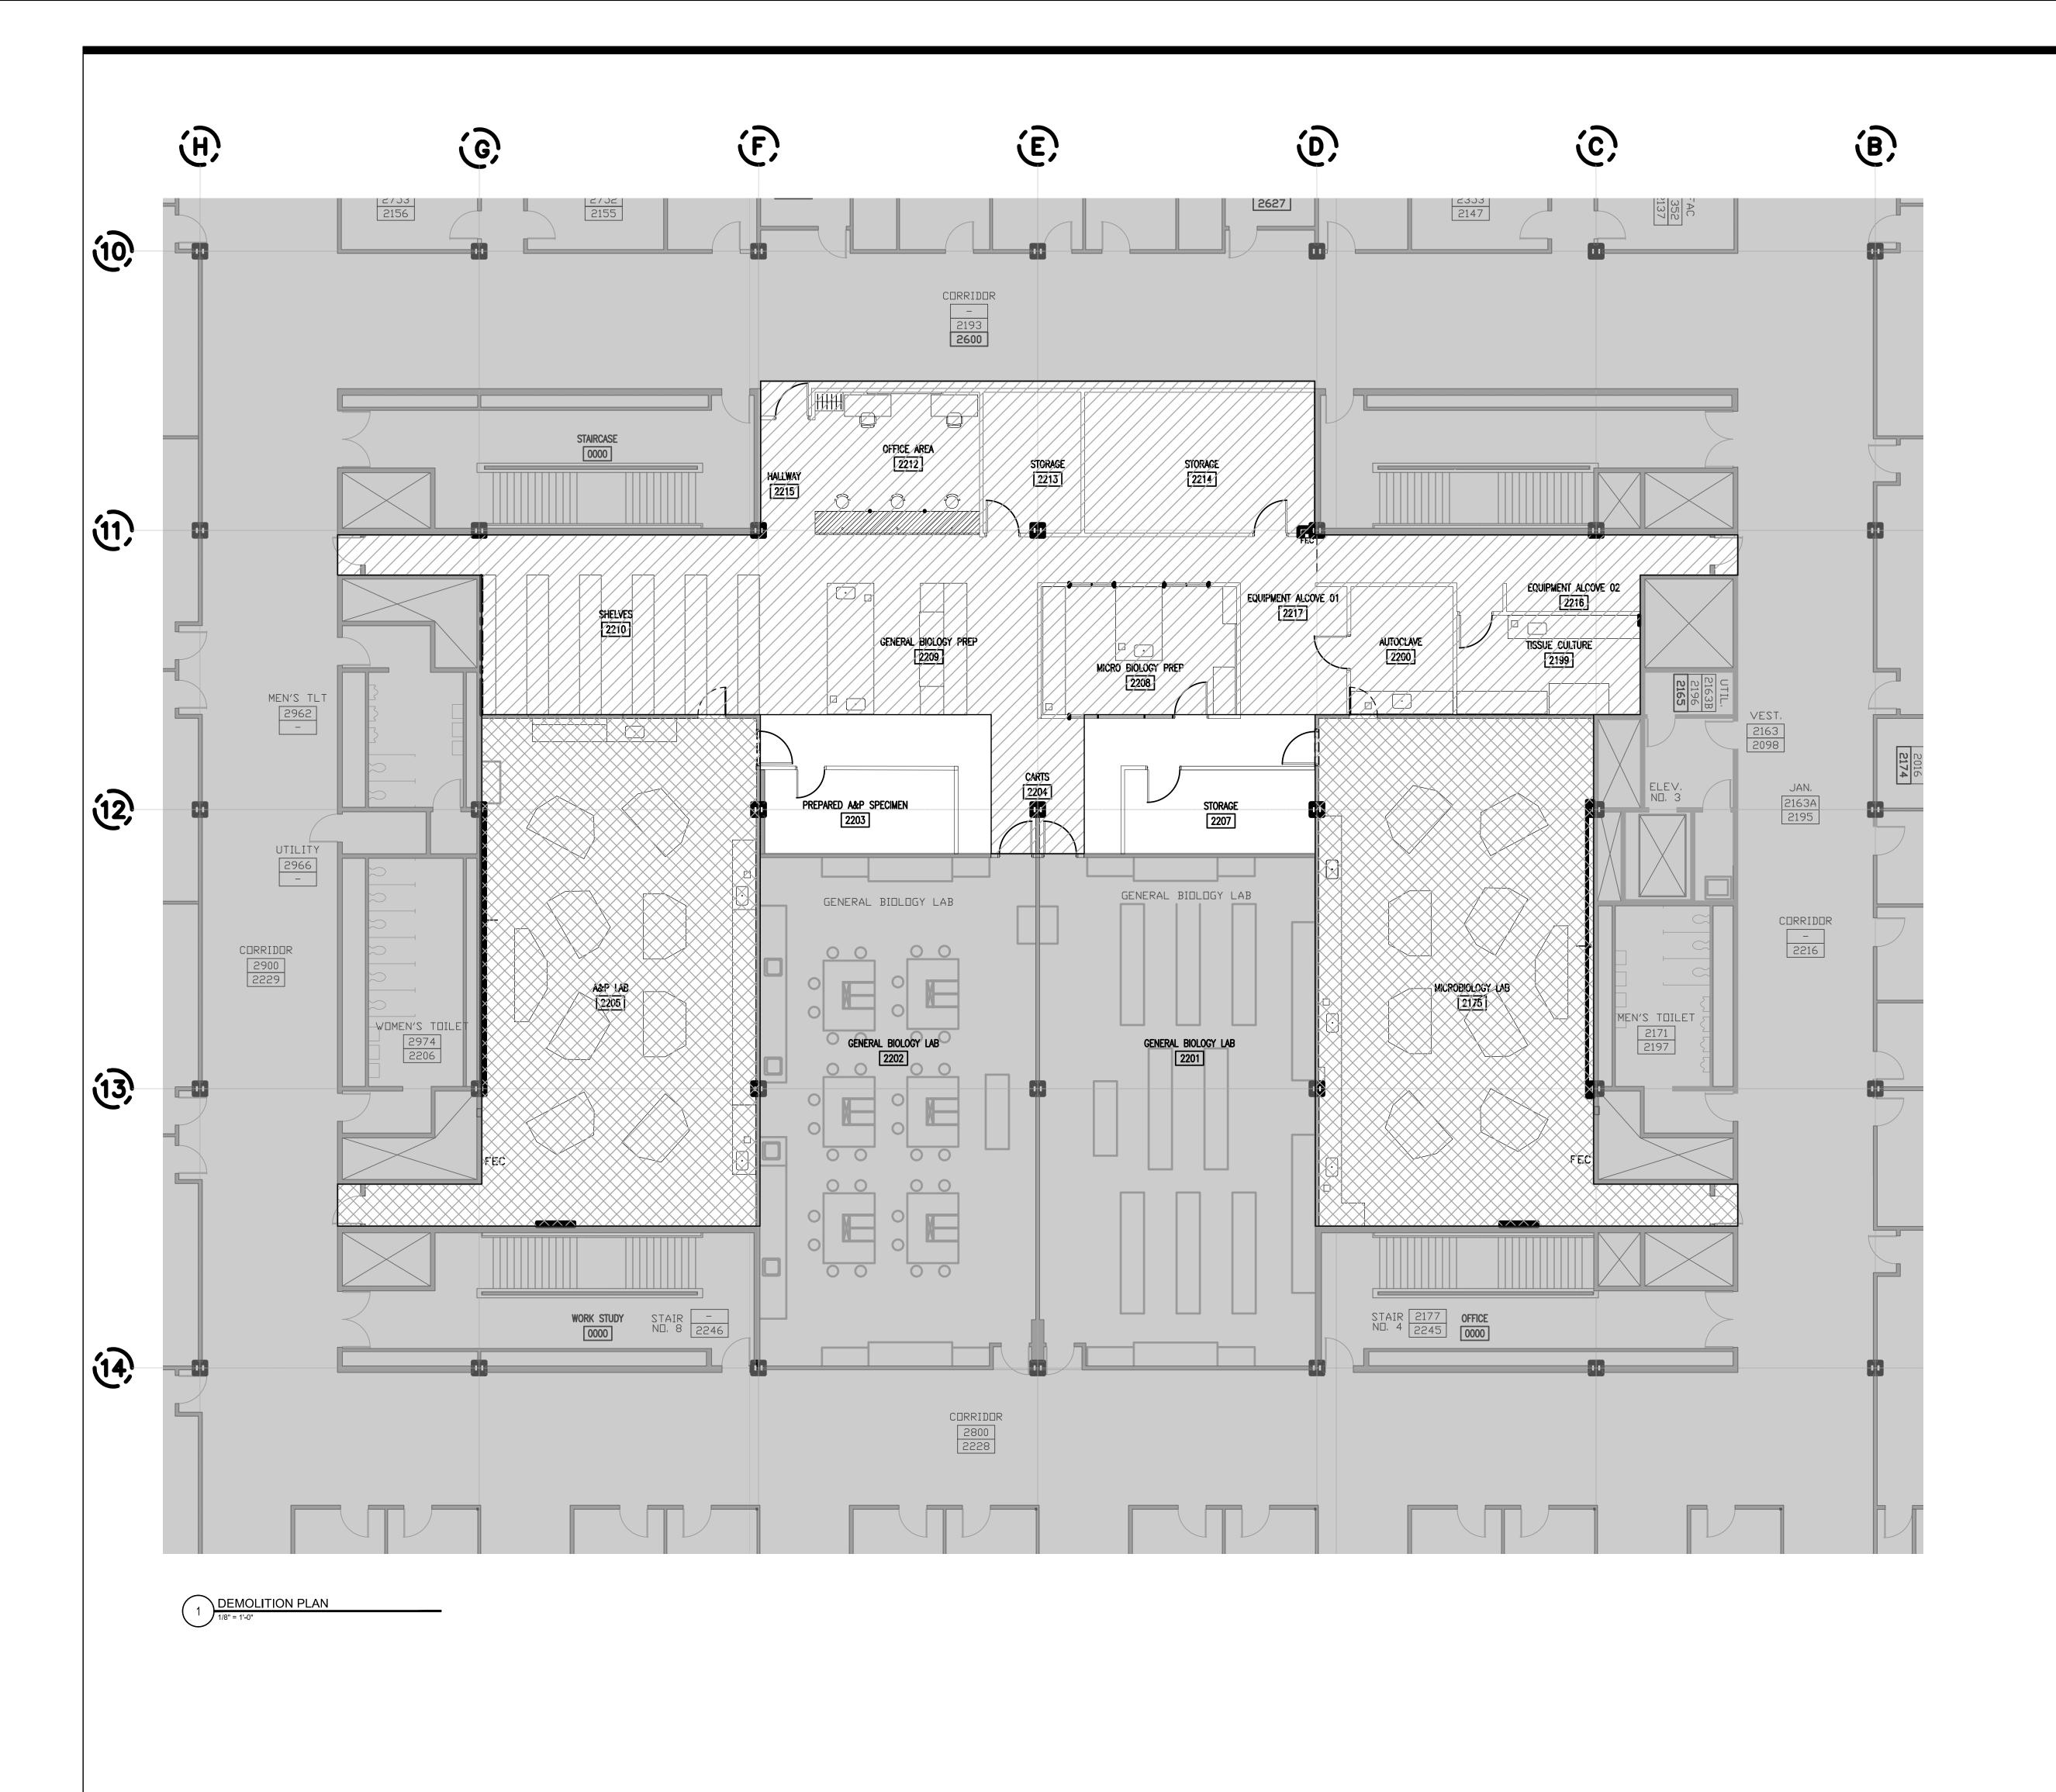
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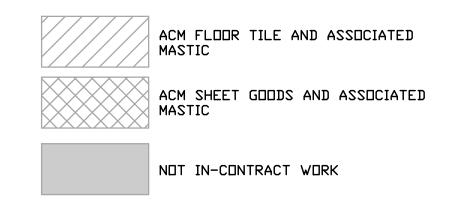
-TRUMAN COLLEGE

PROJECT NUMBER:

PROJECT MANAGER:

ARCH/ENG:





#### ASBESTOS ABATEMENT GENERAL NOTES

1. THE ABATEMENT CONTRACTOR SHALL ABATE, REMOVE, AND DISPOSE OF ALL ASBESTOS CONTAINING MATERIAL (ACM), IN ACCORDANCE WITH APPLICABLE FEDERAL, STATE, AND LOCAL REGULATIONS.

2.LOCATIONS AND QUANTITIES OF ACM IDENTIFIED ON THESE DRAWINGS AND IN THE SUPPLIED SPECIFICATIONS AND SUPPORTING DOCUMENTS ARE FOR GENERAL REFERENCE PURPOSES AND MAY NOT REFLECT EXACT LOCATION AND QUANTITY OF ALL ACM LOCATED WITHIN THE SCOPE OF WORK.

3.THE ABATEMENT CONTRACTOR SHALL FIELD VERIFY CONDITIONS AND QUANTITY OF ACM AND DEMOLITION MATERIALS BEFORE BIDDING, AND IS RESPONSIBLE TO ABATE, REMOVE, AND DISPOSE OF ALL ACM, SURFACES, COMPONENTS AND FIXTURES THAT HAVE OR ARE IMPACTED BY ACM.

4.THE CONTRACTOR SHALL ABATE, REMOVE, AND DISPOSE OF ALL LAYERS OF FLOOR TILE, LINOLEUM SHEET GOODS AND ASSOCIATED MASTIC ADHESIVES FROM FLOORS. ALL INSTALLED RESILIENT FLOORING SHALL BE TREATED AS ACM. ALL ACM FLOORING WILL BE REMOVED TO CLEAN, BARE CONCRETE.
5.PAPER BACKED FIBERGLASS, FOAM AND RUBBER THERMAL SYSTEM INSULATION (TSI) IS NON-ACM AND IS NOT REQUIRED TO BE ABATED AS ACM.
6.THE ABATEMENT CONTRACTOR SHALL REFER TO AND COORDINATE WORK WITH ARCHITECTURAL DEMOLITION PLANS AND SPECIFICATIONS AND MECHANICAL

ELECTRICAL AND PLUMBING PLANS AND SPECIFICATIONS.

7.THE CONTRACTOR SHALL REMOVE AND DISPOSE OF ALL FURNISHINGS, EQUIPMENT AND OTHER PRODUCTS THAT REMAIN.


8.ALL PLUMBING SYSTEMS, NOT SCHEDULED FOR DEMOLITION, REMOVAL AND/OR REPLACEMENT, INCLUDING BUT NOT LIMITED TO DOMESTIC HOT WATER, DOMESTIC COLD WATER, HOT WATER RECIRCULATION, WASTE AND VENT SYSTEMS THAT ARE TO REMAIN ARE TO BE PROTECTED FROM DAMAGE. THE ABATEMENT CONTRACTOR SHALL REFER TO AND COORDINATE WORK WITH ARCHITECTURAL DEMOLITION PLANS AND SPECIFICATIONS AND MECHANICAL ELECTRICAL AND PLUMBING PLANS AND

9.REFER TO ARCHITECTURAL DEMOLITION DRAWINGS FOR PLUMBING AND MECHANICAL DEMOLITION.
10. DRYWALL AND ASSOCIATED JOINT COMPOUND IS POSITIVE FOR ACM CONTENT.
11. LAB HOODS WITHIN THE SCOPE OF WORK AREA CONTAIN TRANSITE PANELS THAT

ARE POSITIVE FOR ACM.

12. THE CONTRACTOR SHALL ABATE, REMOVE AND DISPOSE OF ALL EXISTING SINK TRAPS AND TRAP SEPARATORS IN PLACE. ALL WASTE SHALL BE COLLECTED, TESTED AND DISPOSED OF BY THE CONTRACTOR IN COORDINATION WITH THE UNIVERSITY FACILITIES AND SERVICES IN ACCORDANCE WITH THE SPECIFICATIONS.

13. THE LABORATORY HOODS AND ASSOCIATED EXHAUST DUCTING HAVE BEEN USED OVER THE YEARS FOR A MULTITUDE OF KNOWN AND UNKNOWN CHEMICAL AGENTS, AND MUST BE HANDLED AS HAZARDOUS WASTE. THE CONTRACTOR SHALL DECOMMISSION, DECONTAMINATE, ABATE, REMOVE AND DISPOSE OF ALL EXISTING LABORATORY HOODS INCLUDING, DUCT SYSTEMS, FANS, EXHAUST STACKS, AND ANY OTHER COMPONENTS ASSOCIATED WITH THE HOOD THAT MAY HAVE BEEN IMPACTED BY CHEMICALS IN COORDINATION WITH THE COLLEGE FACILITIES AND SERVICES IN ACCORDANCE WITH SPECIFICATIONS.

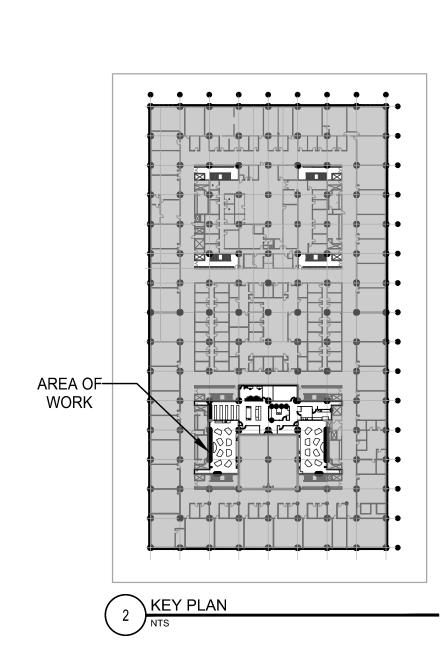



Lab Design Architect

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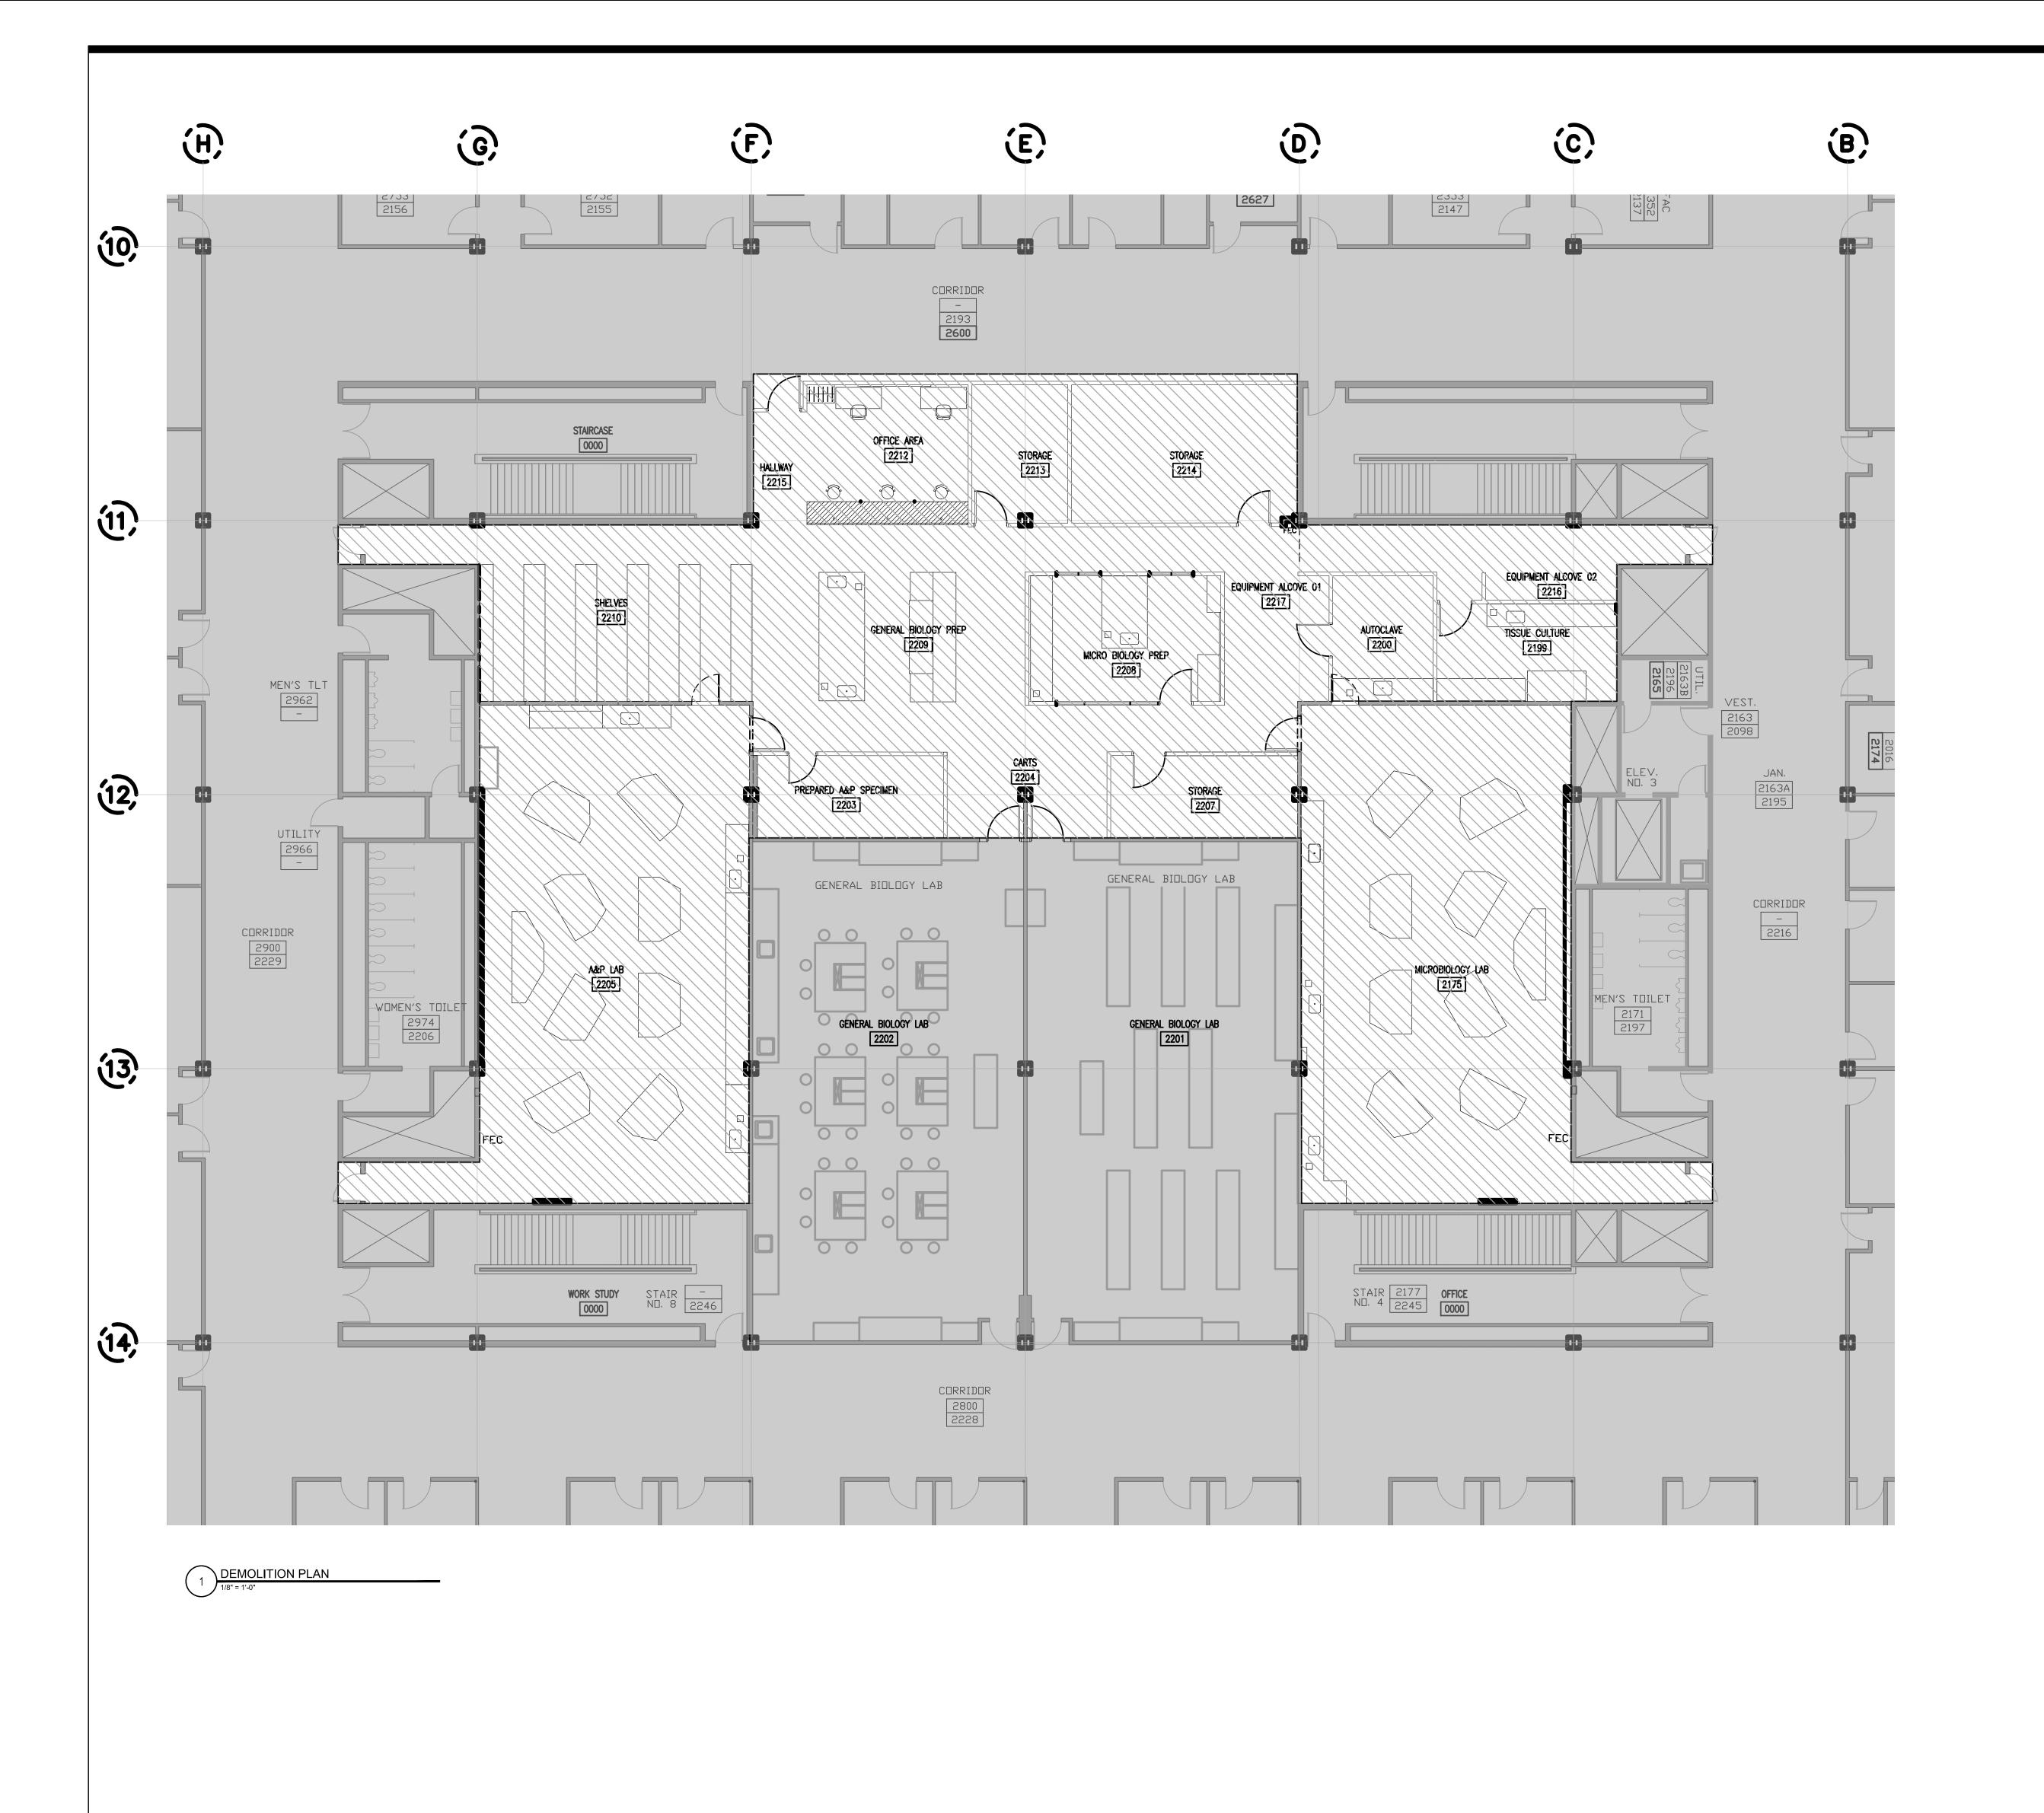
ABATEMENT PLAN SECOND FLOOR


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CHECKED BY:

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FM





#### ASBESTOS ABATEMENT GENERAL NOTES

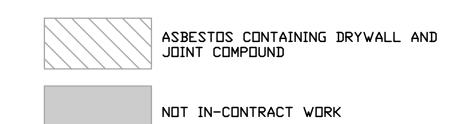AND OTHER PRODUCTS THAT REMAIN.

1. THE ABATEMENT CONTRACTOR SHALL ABATE, REMOVE, AND DISPOSE OF ALL ASBESTOS CONTAINING MATERIAL (ACM), IN ACCORDANCE WITH APPLICABLE FEDERAL, STATE, AND LOCAL REGULATIONS.

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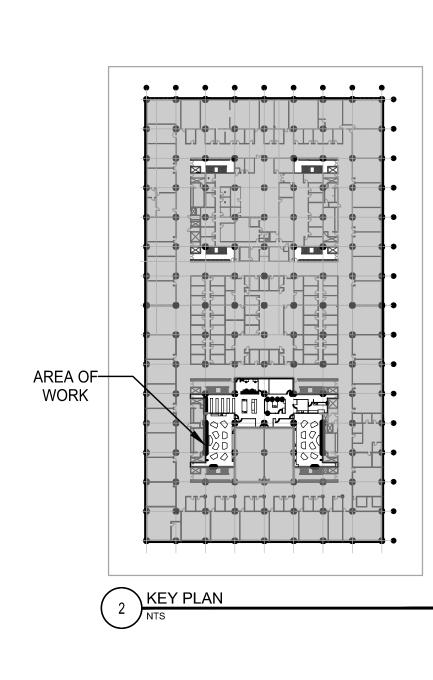
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CITY COLLEGES of CHICAGO

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-TRUMAN COLLEGE PROJECT NUMBER: 42280

PROJECT MANAGER: ARCH/ENG: SCALE: 1/8" = 1'-0' DRAWN BY: FM CHECKED BY:

ABATEMENT PLAN

SECOND FLOOR


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KEY NOTES

<u>KEYNOTES</u>

01) FLOOR DRAIN TO BE REMOVED AND REPLACED.

 $\langle 02 \rangle$ EXIST FUME HOODS TO BE REMOVED. ─ REMOVE AND DISPOSE THROUGH AN

ABATEMENT PROCESS. (03) EXISTING STUDENT LAB BENCH TO ─ BE REMOVED.

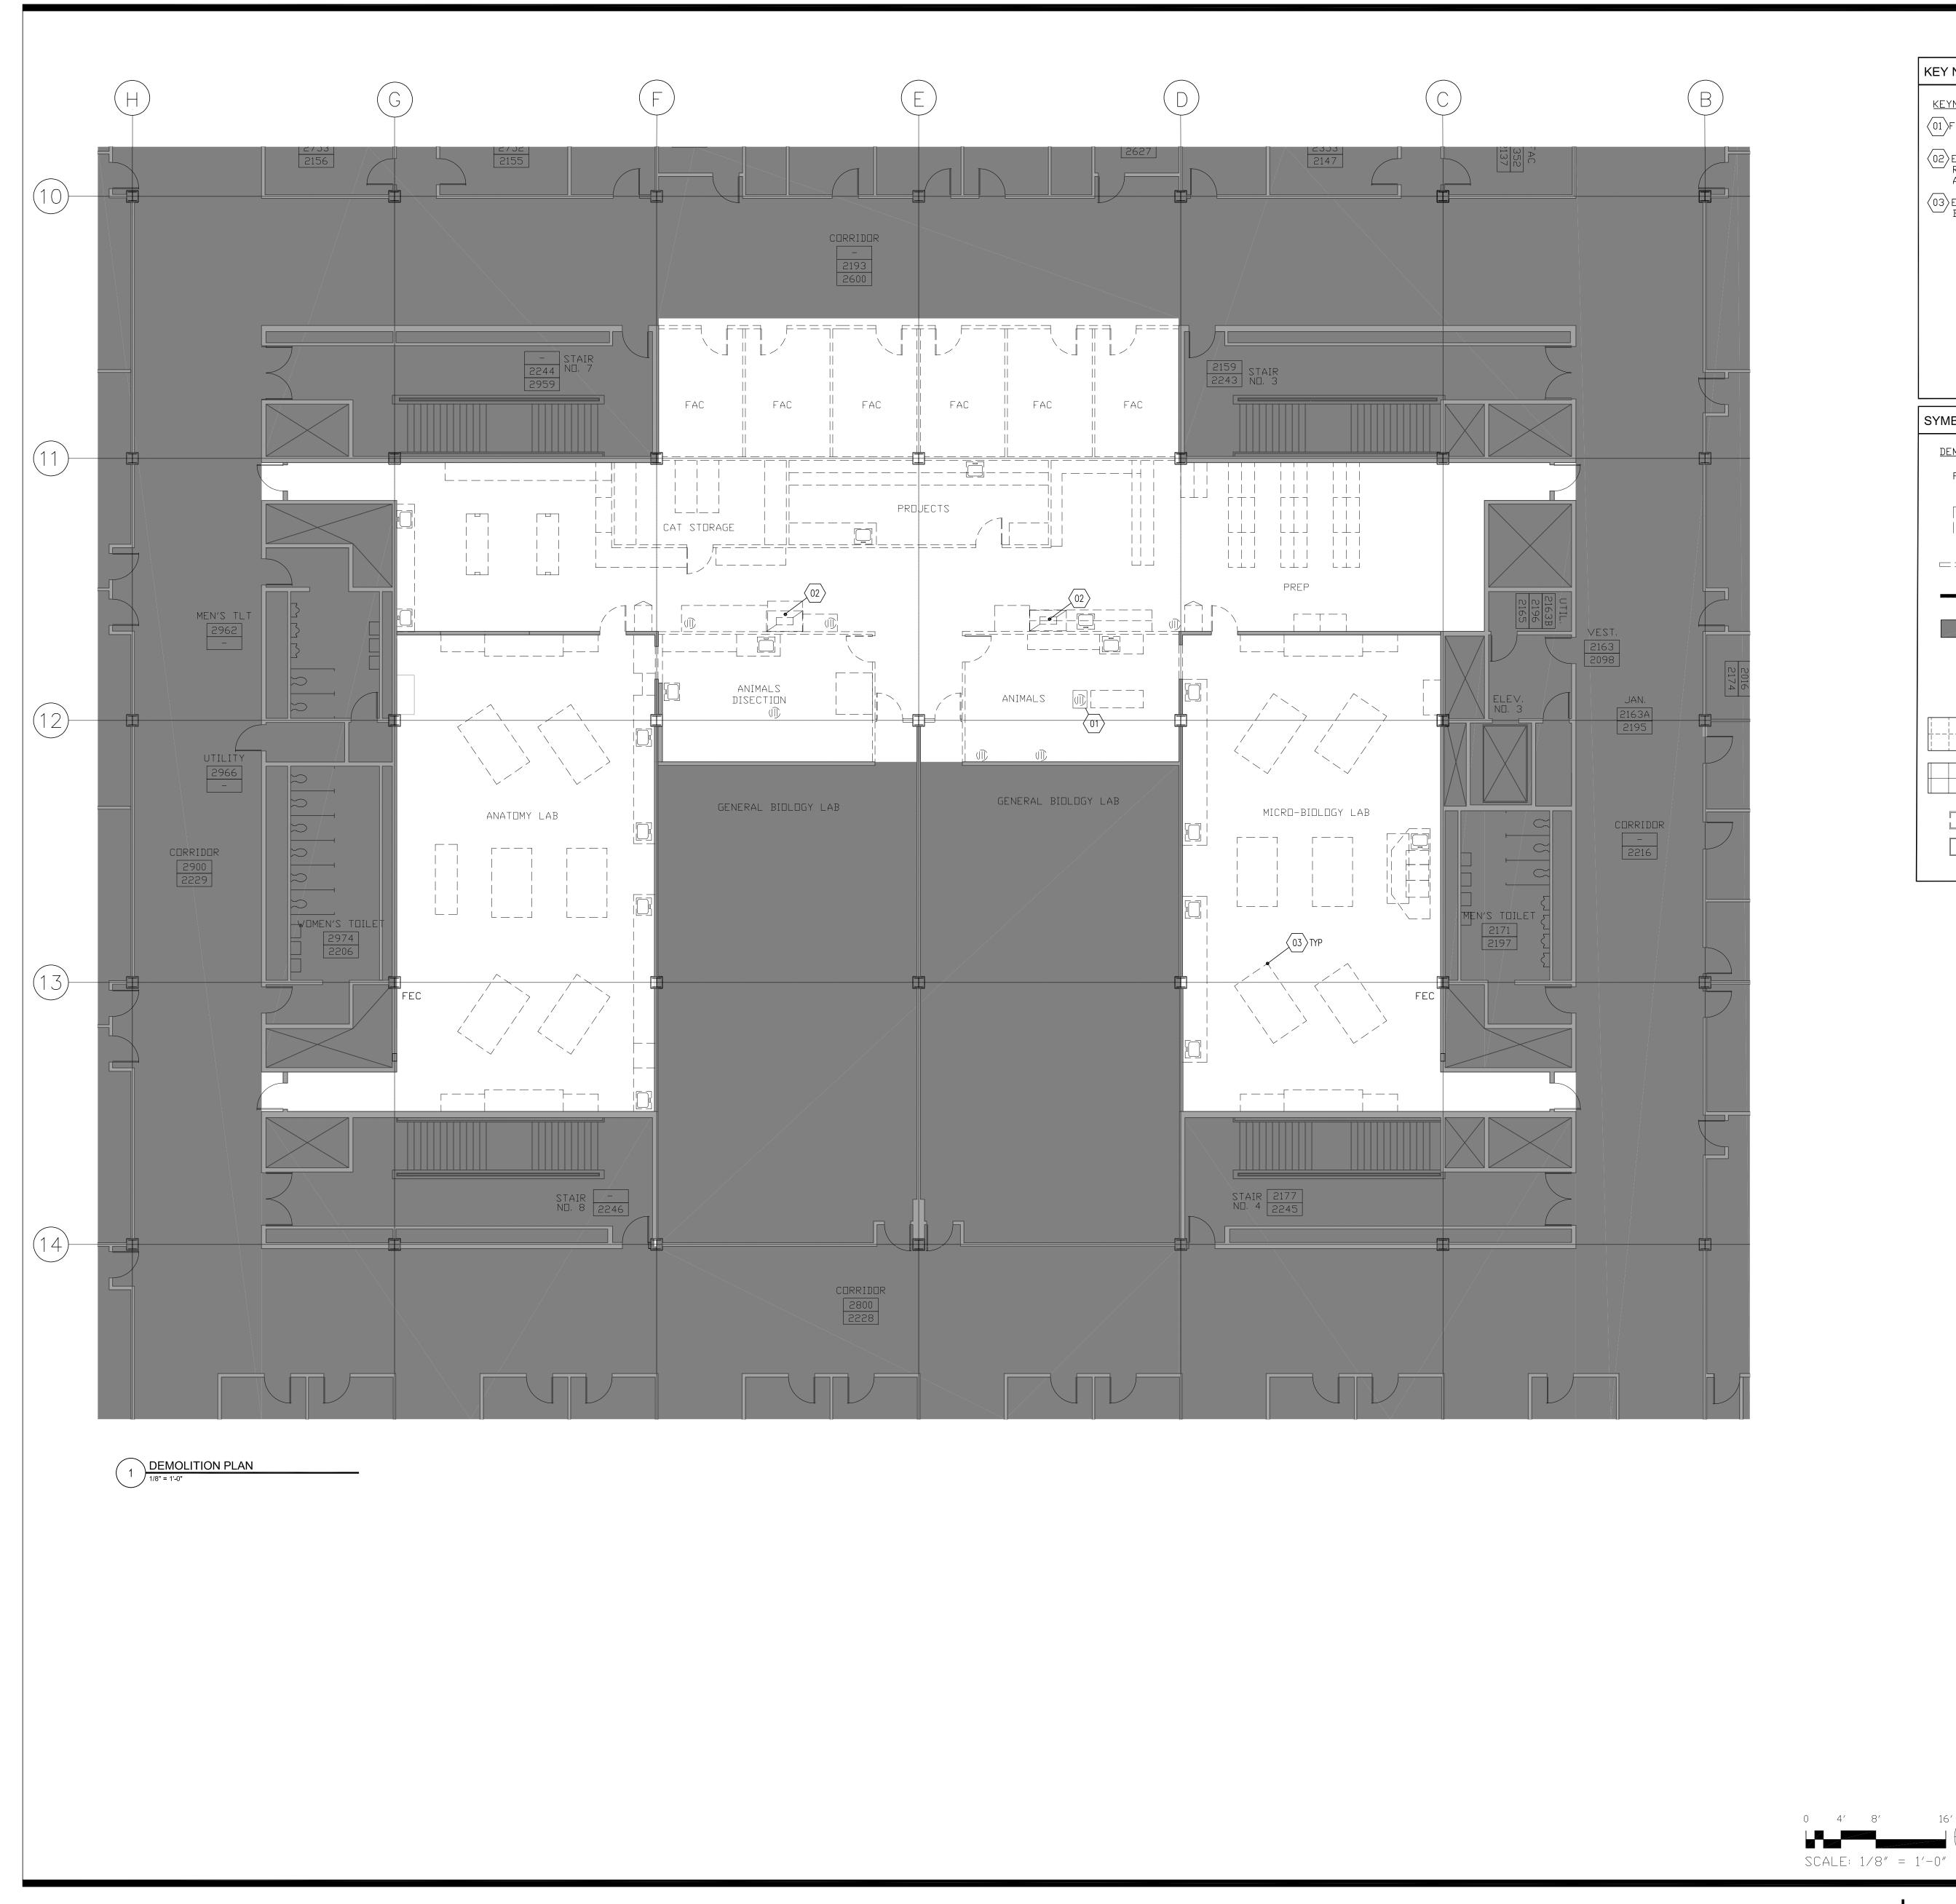SYMBOL LEGEND

DEMOLITION PLAN LEGEND F.E.C. EXISTING FIRE EXTINGUISHER CABINET TO REMAIN REMOVE DOOR AND FRAME. SALVAGE. REMOVE PARTITION EXISTING PARTITION TO REMAIN NOT IN CONTRACT FLOOR DRAIN TO BE REMOVED/DEMOLISHED. PATCH AND REPAIR FLOOR EXIST CEILING GRID & H--------- PANELS TO BE DEMOLISHED EXIST CEILING GRID TO REMAIN DEMOLISH EXIST. ACOUSTIC
PANELS

DEMO CEILING FIXTURES

EX CEILING FIXTURES

 $ldsymbol{\mathsf{L}} = ldsymbol{\mathsf{L}}$ 

DEMOLITION NOTES

GENERAL NOTES

SALVAGE DOORS AND FRAMES RETURN TO OWNER. SALVAGE LEVER HANDLE DOOR HARDWARE FOR RE-USE, RETURN UNUSED

HARDWARE TO OWNER. REMOVE EXISTING FLOOR FINISHES THROUGH HAZARDOUS MATERIALS ABATEMENT PROCESS

AND PREPARE FLOOR FOR NEW FINISH. B. DEMOLISH AND DISPOSE OF INDICATED GYP.BD. PARTITIONS THROUGH A HAZARDOUS MATERIALS ABATEMENT PROCESS.

4. ALL ITEMS TO BE REMOVED FOR REINSTALLATION OR TO BE RETURNED TO OWNER SHALL BE PROTECTED, CLEAN AND FREE FROM DAMAGE. FOR ALL ITEMS SCHEDULED FOR REMOVAL AND REINSTALLATION, THE CONTRACTOR SHALL VERIFY AND PROVIDE DOCUMENTATION OF THE CONDITION AND FUNCTIONALITY OF THE ITEMS PRIOR TO REMOVAL. ITEMS WITH UNDOCUMENTED DAMAGE SHALL BE REPAIRED OR REPLACED BY THE

CONTRACTOR AT NO COST TO THE OWNER. THE CONTRACTOR SHALL MAINTAIN THE AREA OF DEMOLITION AND CONSTRUCTION IN A CLEAN AND ORDERLY CONDITION WITH DAILY REMOVAL OF DEBRIS. THE SITE SHALL BE LEFT BROOM CLEAN. COORDINATE REMOVAL OF DEBRIS WITH MUNICIPAL AND OWNER'S RULES AND REQUIREMENTS.

THE CONTRACTOR SHALL PERFORM ALL CUTTING, PATCHING AND REPAIRING REQUIRED TO DO THE WORK INDICATED IN THE DOCUMENTS. ALL CUTTING AND REMOVALS SHALL BE DONE NEATLY. ALL EXISTING SURFACES AND EQUIPMENT THAT

REMAIN SHALL BE FULLY PROTECTED FROM

DAMAGE. THE CONTRACTOR SHALL BE RESPONSIBLE

FOR ALL DAMAGE AND SHALL MAKE REPAIRS AT NO ADDITIONAL COST TO OWNER. 8. ALL EXISTING FURNITURE AND EQUIPMENT THAT WILL BE REMOVED OUT FROM PROJECT AREA FOR CONSTRUCTION PURPOSE, THE CONTRACTOR SHALL BE RESPONSIBLE FOR THE SAFE RE-LOCATION OF THOSE AND RETURN BACK TO SITE AFTER CONSTRUCTION COMPLETION WITH NO ADDITIONAL

COST TO OWNER ERECT AND MAINTAIN DUSTPROOF BARRIERS TO PREVENT THE SPREAD OF DUST AND FUMES TO OTHER PARTS OF THE BUILDING, UPON COMPLETION OF WORK, REMOVE BARRIERS AND

REPAIR DAMAGED SURFACES TO MATCH ADJACENT. 10. PROTECT HVAC SYSTEM FROM DUST AND DEBRIS. CONTRACTOR TO PROVIDE FILTER MEDIA TO COVER THE MAIN RETURN AIR GRILLES. PROVIDE NEW FILTERS FOR MECHANICAL UNITS AT THE

COMPLETION OF THE CONSTRUCTION WORK. 1. CONTRACTOR SHALL COORDINATE THE SHUTDOWN OF BUILDING SYSTEMS WITH THE OWNER PRIOR TO IMPLEMENTATION.

12. COMPLY WITH APPLICABLE LOCAL, STATE AND FEDERAL CODES AND REGULATIONS PERTAINING TO THE SAFETY OF PERSONS, PROPERTY AND

EN∨IRONMENTAL PROTECTION. 13. ANNOYANCES AND DISTURBANCES SHALL BE KEPT TO A MINIMUM AS NECESSARY FOR THE


14. REMOVE ALL EXISTING MATERIALS AND ITEMS WHICH CAUSE RISES OR DEPRESSIONS IN THE FLOORING SURFACE.

PERFORMANCE OF THE WORK.

15, REFER TO ENGNEERING DRAWINGS FOR THE SCOPE OF REMOVAL OF ELECTRICAL, PLUMBING AND HVAC ITEMS.

16. NO STRUCTURAL ELEMENTS SHALL BE REMOVED. 17. REMOVE EXISTING WALL BASE IN ALL PROJECT AREAS, PREP EXISTING WALLS TO REMAIN TO RECEIVE NEW BASE.

18. DEMOLISH ALL ELECTRICAL, MECHANICAL AND PLUMBING ITEMS INDICATED FOR DEMOLITION BACK TO THEIR SOURCE U.N.O. REFER TO ENGINEERING DRAWINGS.

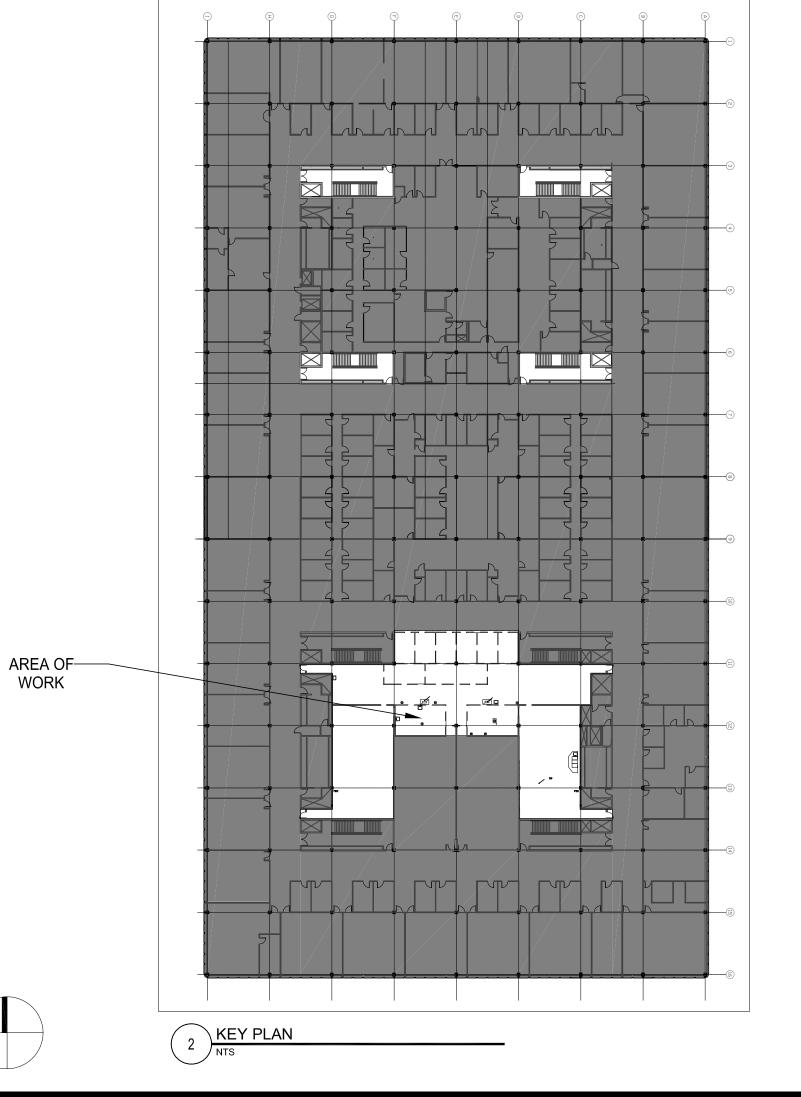

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NO. DATE REVISIONS/ISSUANCES **ARCHITECTURE** & DESIGN

CITY COLLEGES OF CHICAGO -TRUMAN COLLEGE

PROJECT NUMBER: 42280 PROJECT MANAGER: ARCH/ENG: SCALE: 1/8" = 1'-0' NR DRAWN BY: RC

SECOND FLOOR

CHECKED BY:

**DEMOLITION PLAN** 

Lab Design Architect HOLABIRD & ROOT

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CCJM E Wacker Dr #303 Chicago, IL 60601 312.669.0609 www.ccjm.com

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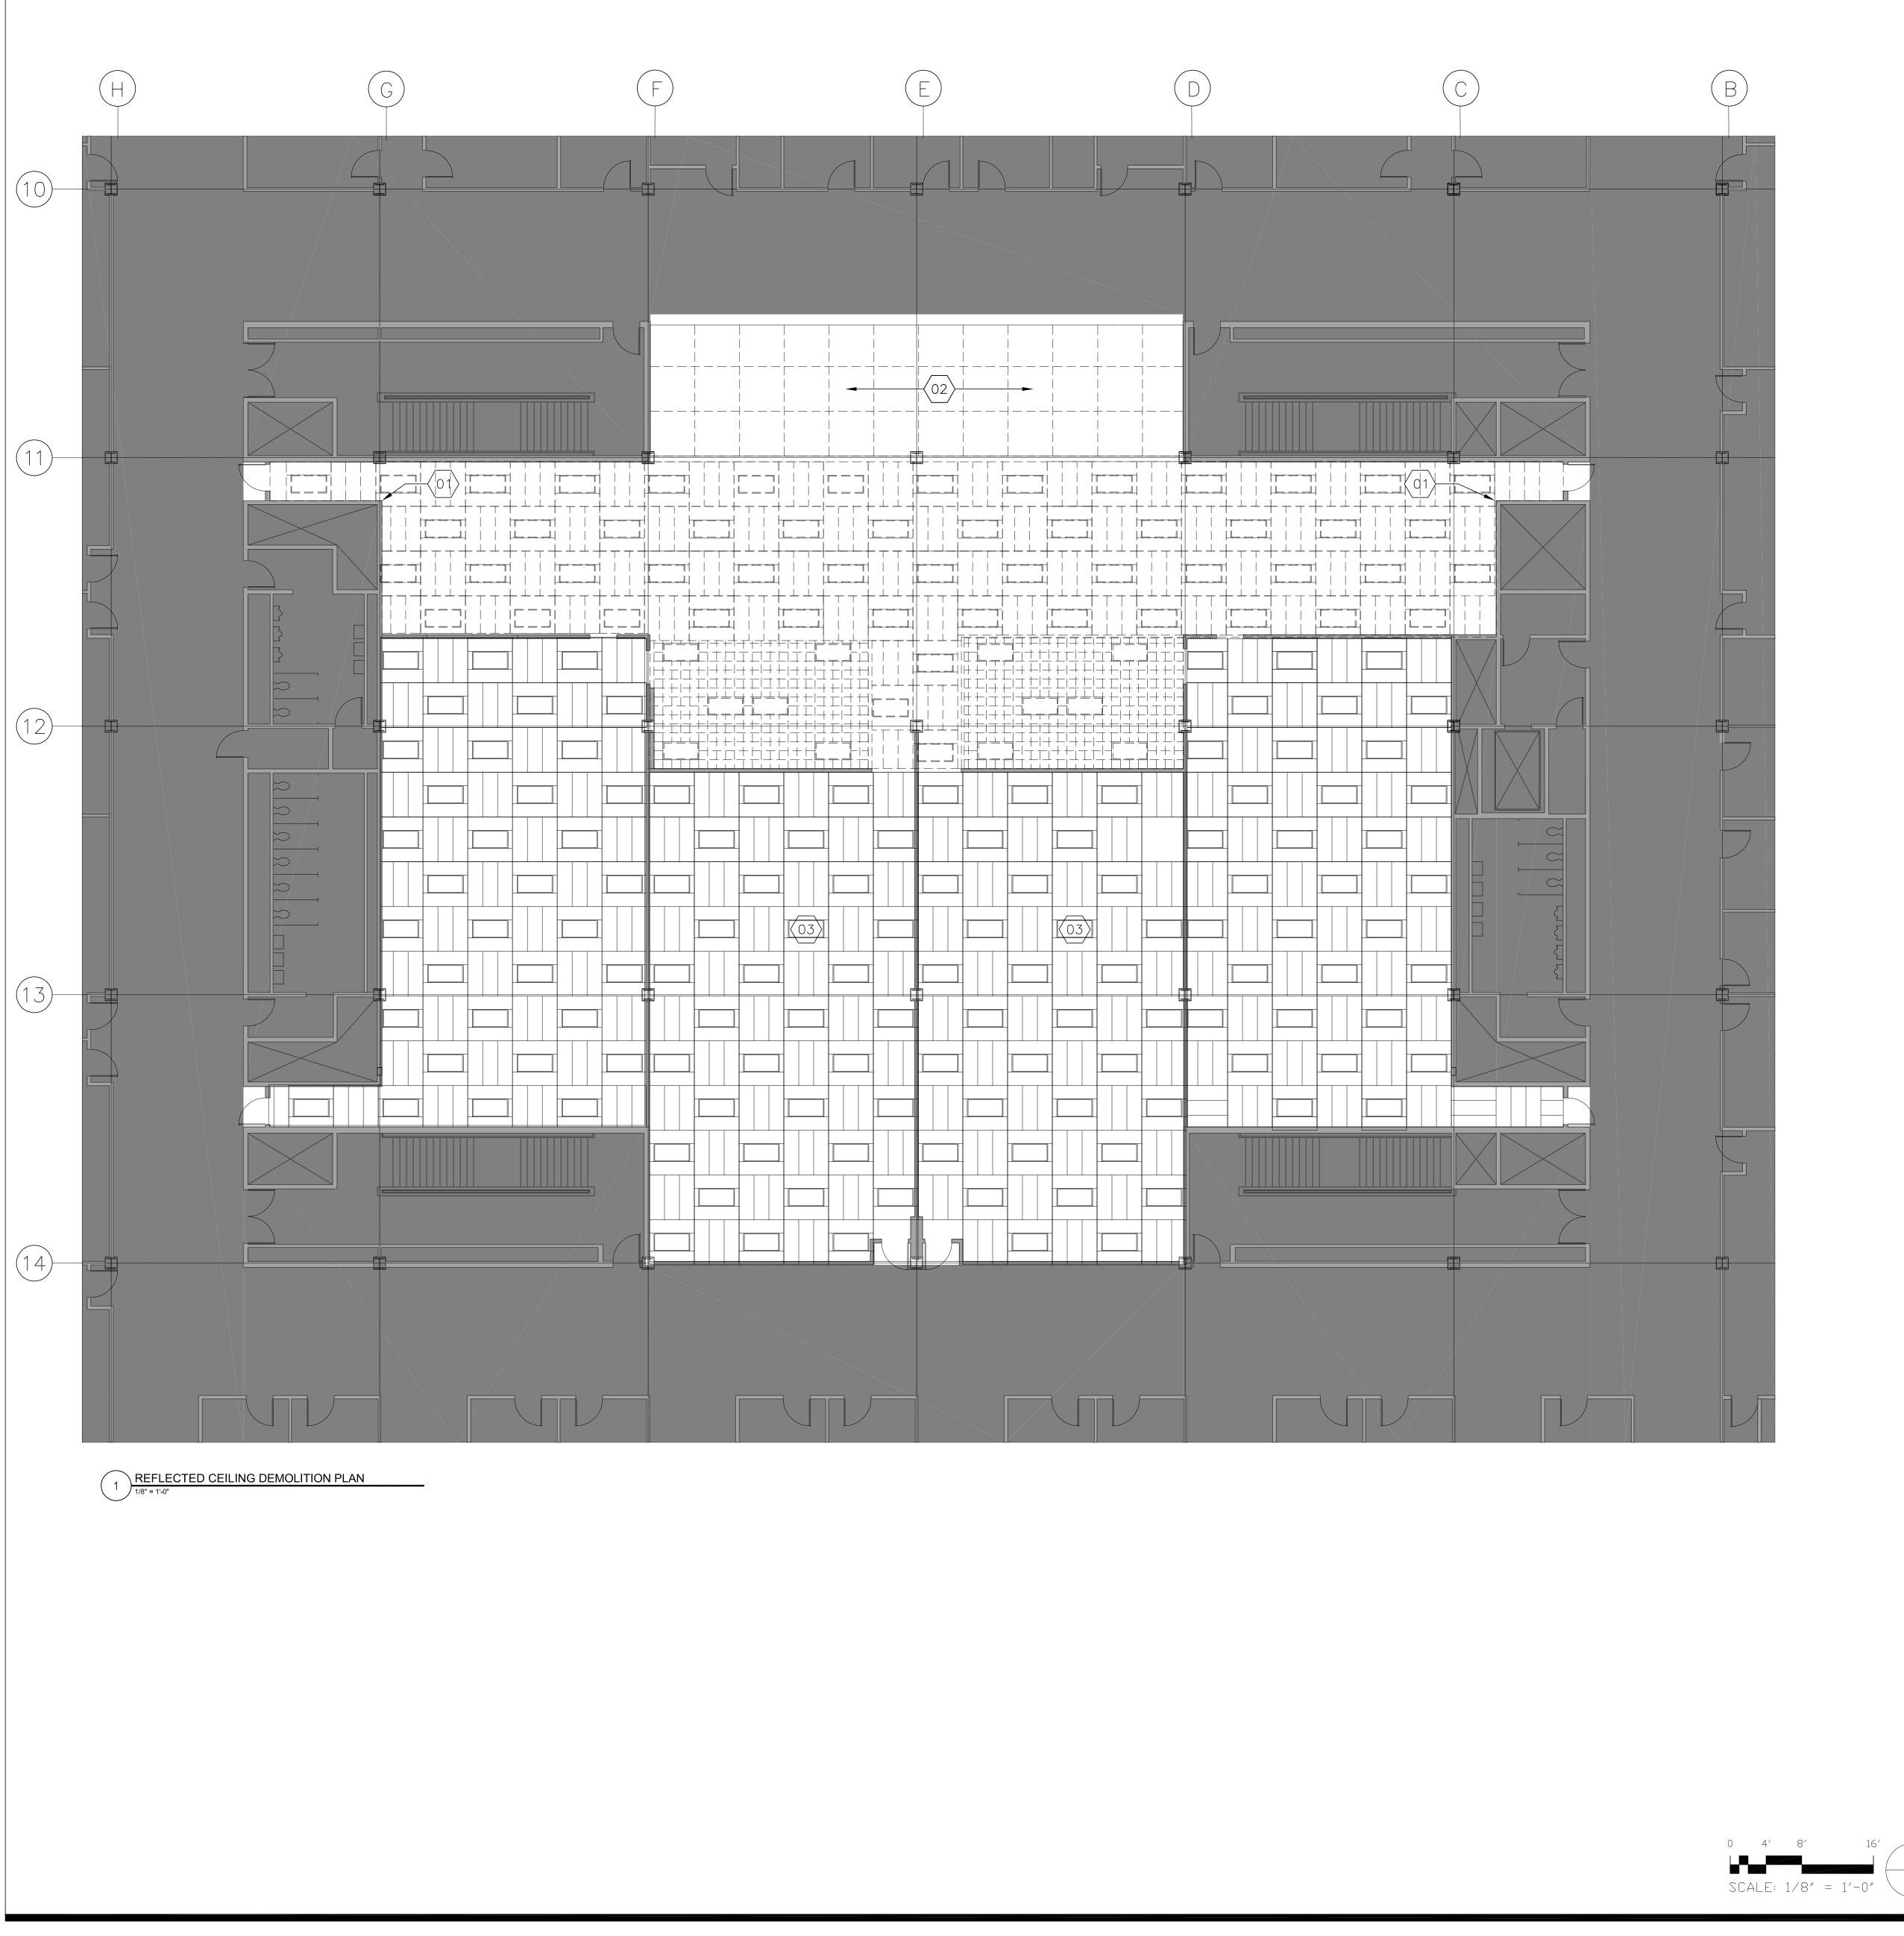
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SYMBOL LEGEND

<u>DEMOLITION PLAN LEGEND</u>

F.E.C. EXISTING FIRE EXTINGUISHER

CABINET TO REMAIN □□ REMOVE DOOR, SALVAGE

WHERE INDICATED

EXISTING PARTITION TO REMAIN

NOT IN CONTRACT

EXIST CEILING GRID TO BE DEMOLISHED. REMOVE AND SALVAGE ACCUSTICAL

□ □ □ REMOVE CEILING FIXTURES

EX CEILING FIXTURES


#### DEMOLITION NOTES


- 1. SALVAGE CEILING TILES FOR RE-INSTALLATION 2. SALVAGE LIGHT FIXTURES FOR
- RE-INSTALLATION 3. SALVAGE CEILING PANELS FOR
- RE-USE 4. COORDINATE REMOVAL & SALVAGE
- OF AV EQUIPMENT WITH OWNER. REMOVE AND SALVAGE FOR REINSTALLATION AREAS OF 1ST FLOOR CEILING REQUIRED FOR DEMOLITION AND INSTALLATION OF MECHANICAL, ELECTRICAL AND PLUMBING. CO-ORDINATE WITH ENGINEERING DRAWINGS, INSTALL NEW CEILING TO REPLACE DAMAGED CEILING.

#### KEY NOTES (

KEY NOTES

- (01) EXIST. WALL MTD. EXIT SIGN TO REMAIN
- 02) REMOVE EXIST, CEILING AND LIGHT FIXTURES IN OFFICES
- 03) REMOVE AND SALVAGE FOR REINSTALLATION AREAS OF CEILING REQUIRED FOR DEMOLITION AND INSTALLATION OF MECHANICAL, ELECTRICAL AND PLUMBING. CO-ORDINATE WITH ENGINEERING DRAWINGS. INSTALL NEW CEILING TO REPLACE DAMAGED CEILING.

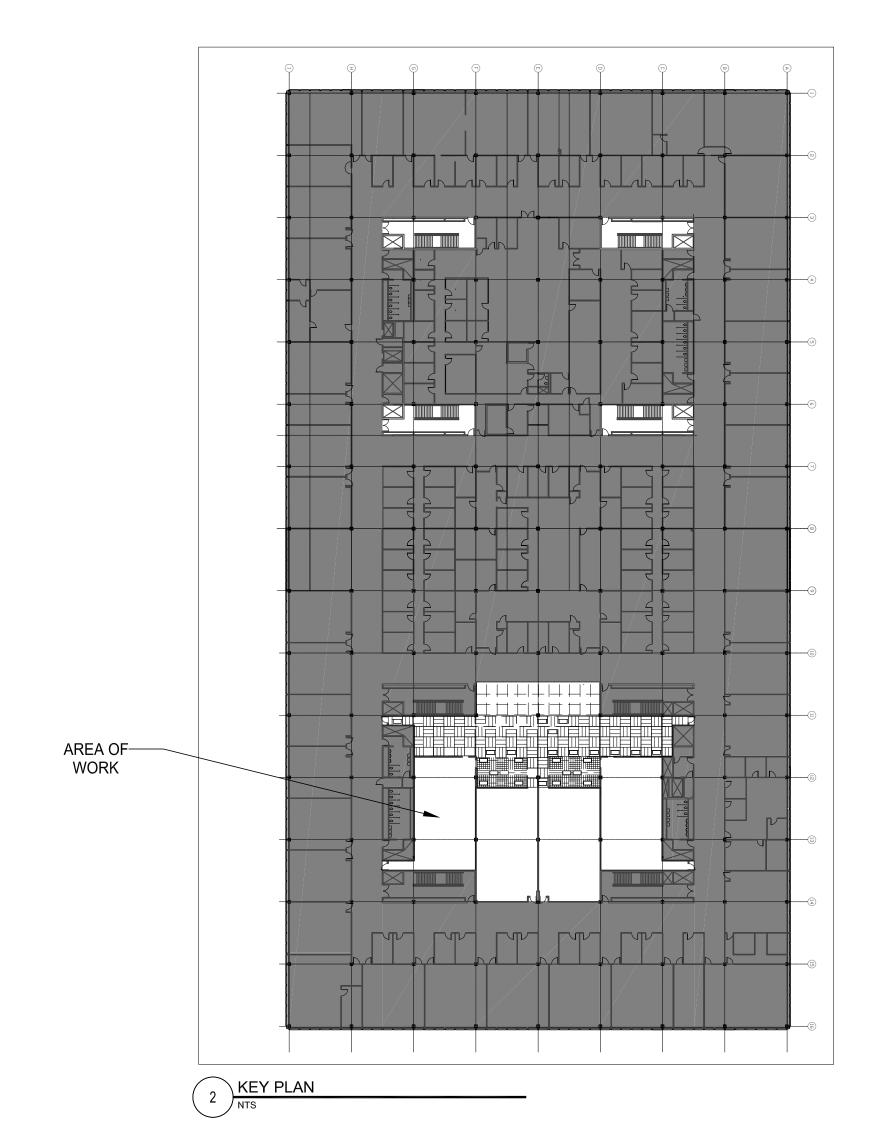

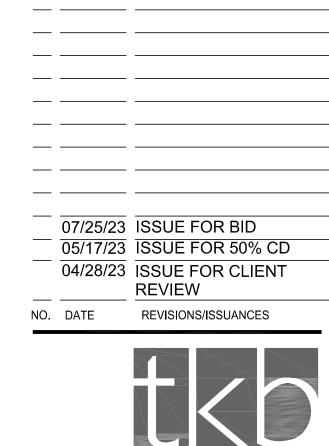

& DESIGN CITY COLLEGES OF CHICAGO -TRUMAN COLLEGE

PROJECT NUMBER: 42280 PROJECT MANAGER: ARCH/ENG: SCALE: 1/8" = 1'-0'

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SECOND FLOOR REFLECTED CEILING **DEMOLITION PLAN** 


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SEAL


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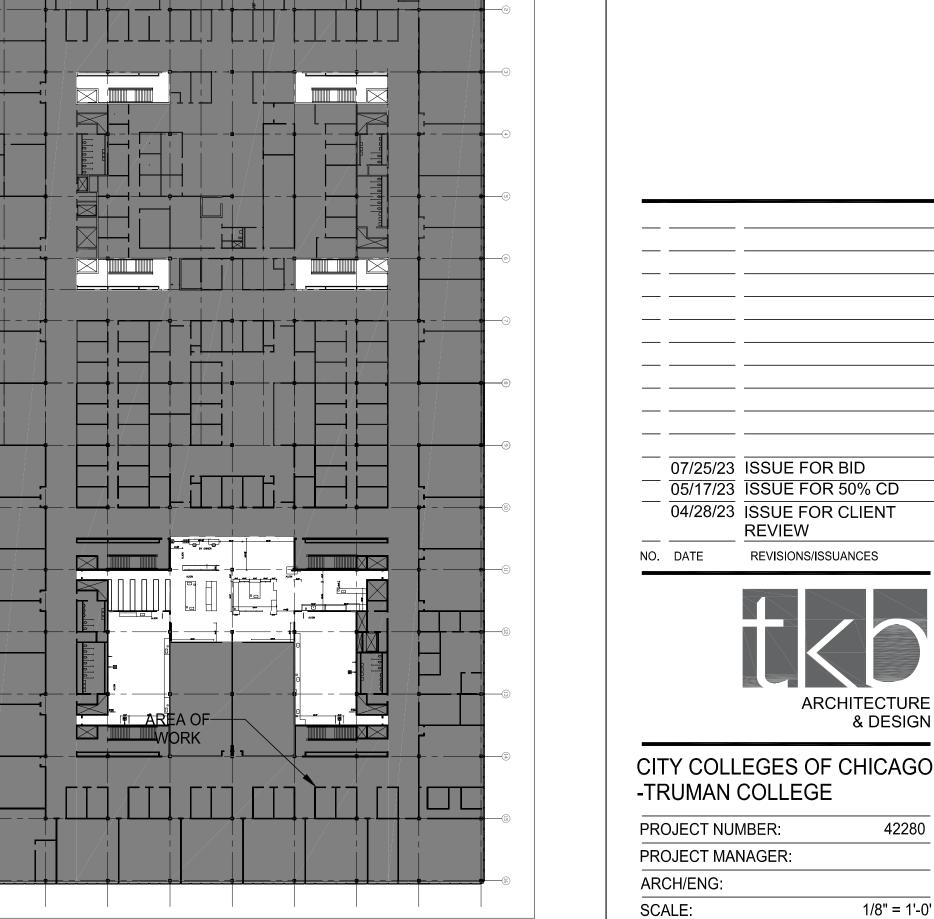
NR

RC



KEY NOTES GENERAL NOTES ALL PARTITIONS ARE TYPE A UNLESS (01,)INFILL TO MATCH ADJACENT NOTED OTHERWISE. REFER TO LF-SERIES AND PLUMBING PARTITION. DRAWINGS FOR SINK AND PLUMBING 02. PROVIDE NEW RECESSED BOX WITH WINDOW DOOR FOR GAS LOCATIONS. REFER TO LF-SERIES DRAWINGS FOR SHUT-OFF VALVE. EQUIPMENT AND CASEWORK LOCATIONS. CONFLICTS BETWEEN SITE CONDITIONS AND (03) NEW DOUBLE TIER 5-WIDE DRAWINGS SHALL BE BROUGHT TO THE ─ STANDARD STEEL LOCKERS IMMEDIATE ATTENTION OF THE ARCHITECT. 12"W X 15"D X 66" H. GRAY ALL WORK SHALL BE CONSTRUCTED PLUMB, LEVEL, SQUARE AND TRUE AND IN PROPER 04) PROVIDE IN-WALL BLOCKING ENTIRE WIDTH OF NEW FURRING WALL FOR ALIGNMENT. ALL DIMENSIONS ARE TO FACE OF FINISHED CONSTRUCTION U.N.O. MONITORS & MARKER BOARDS ALL EXISTING PARTITIONS TO REMAIN ARE 05) USE MOLD AND MOISTURE RESISTANT GYP. BD. FOR PARTITIONS IN THIS TO BE PATCHED AND REPAIRED TO MATCH ADJACENT SURFACES. SEAL ABANDONED PENETRATIONS AT FLOORS, WALLS AND SHAFTS TO MAINTAIN FIRE/SMOKE AND ACOUSTICAL RATINGS. 06) PATCH WALLS, FLOORS & CEILINGS ON CORRIDOR SIDE TO MATCH ALL INFILL OF DOORS, WALLS AND OPENINGS SHALL MATCH AND BE FLUSH EXISTING. WITH ADJACENT AND EXISTING PARTITION CONSTRUCTION. (07.) PATCH WALLS, FLOOR AND CEILING PARTITION DEPTH AT FIRE EXTINGUISHER ─/ IN CLASSROOMS TO MATCH EXISTING CABINET LOCATIONS SHALL ACCOMMODATE FULL CONCEALMENT OF THE RECESSED IF ANY NEEDED AS A RESULT OF WORK RELATED TO PROJECT AREA. CABINETS AS SPECIFIED BY THE MANUFACTURER. ALL PARTITIONS ABUTTING COLUMNS ARE TO ALIGN WITH THE FACE OF THE COLUMN CONSTRUCTION OF FIRE-RATED PARTITIONS, INCLUDING TAPING AND FINISHING OF GYPSUM WALLBOARD FOR FULL HEIGHT TO STRUCTURE ABOVE, SHALL BE IN SYMBOL LEGEND ACCORDANCE WITH UL SPECIFICATIONS TO ACHIEVE RATING INDICATED. GYPSUM WALLBOARD ON BOTH SIDES OF F.E.C. **™** EXISTING FIRE ALL PARTITIONS WITH PLUMBING ROUGH-INS SHALL BE WATER-RESISTANT. EXTINGUISHER CABINET TO B. ALL EXPOSED GYPSUM BOARD EDGES SHALL REMAIN HAVE METAL EDGE TRIM. WALL TYPE - SEE SHEET A-108 4. PROVIDE GROUNDS AND BLOCKING IN METAL FRAMED PARTITIONS FOR THE A-108 ANCHORAGE SUPPORT OF ALL WALL HUNG CASEWORK, SHELVING, A/V DEVICES, MARKER BOARDS, ETC. COORDINATE WITH EXISTING PARTITION TO REMAIN LAB CASEWORK DRAWINGS, ALL CONCEALED BLOCKING AND LUMBER SHALL BE FIRE NEW PARTITION AS TREATED. INDICATED REFER TO ENGINEERING DRAWINGS (INCLUDING M2-2, E3-1) FOR ROOFTOP → WEW DOOR 6. REFER LAB DRAWINGS(LF-SERIES) FOR LOCATIONS AND REQUIREMENTS FOR CASEWORK, REFER TO ENGINEERING DRAWINGS AND NEW SIDELIGHT AND LAB DRAWINGS(LF-SERIES) FOR LOCATIONS GLAZING AND REQUIREMENTS FOR POWER, DATA, A/V, MECHANICAL AND PLUMBING. 18. PATCH AND REPAIR ALL WALLS THAT MUST NEW MILLWORK BE OPENED TO ACCOMMODATE THE DEMOLITION AND INSTALLATION OF NEW POWER, DATA, A/V, MECHANICAL AND NOT IN CONTRACT

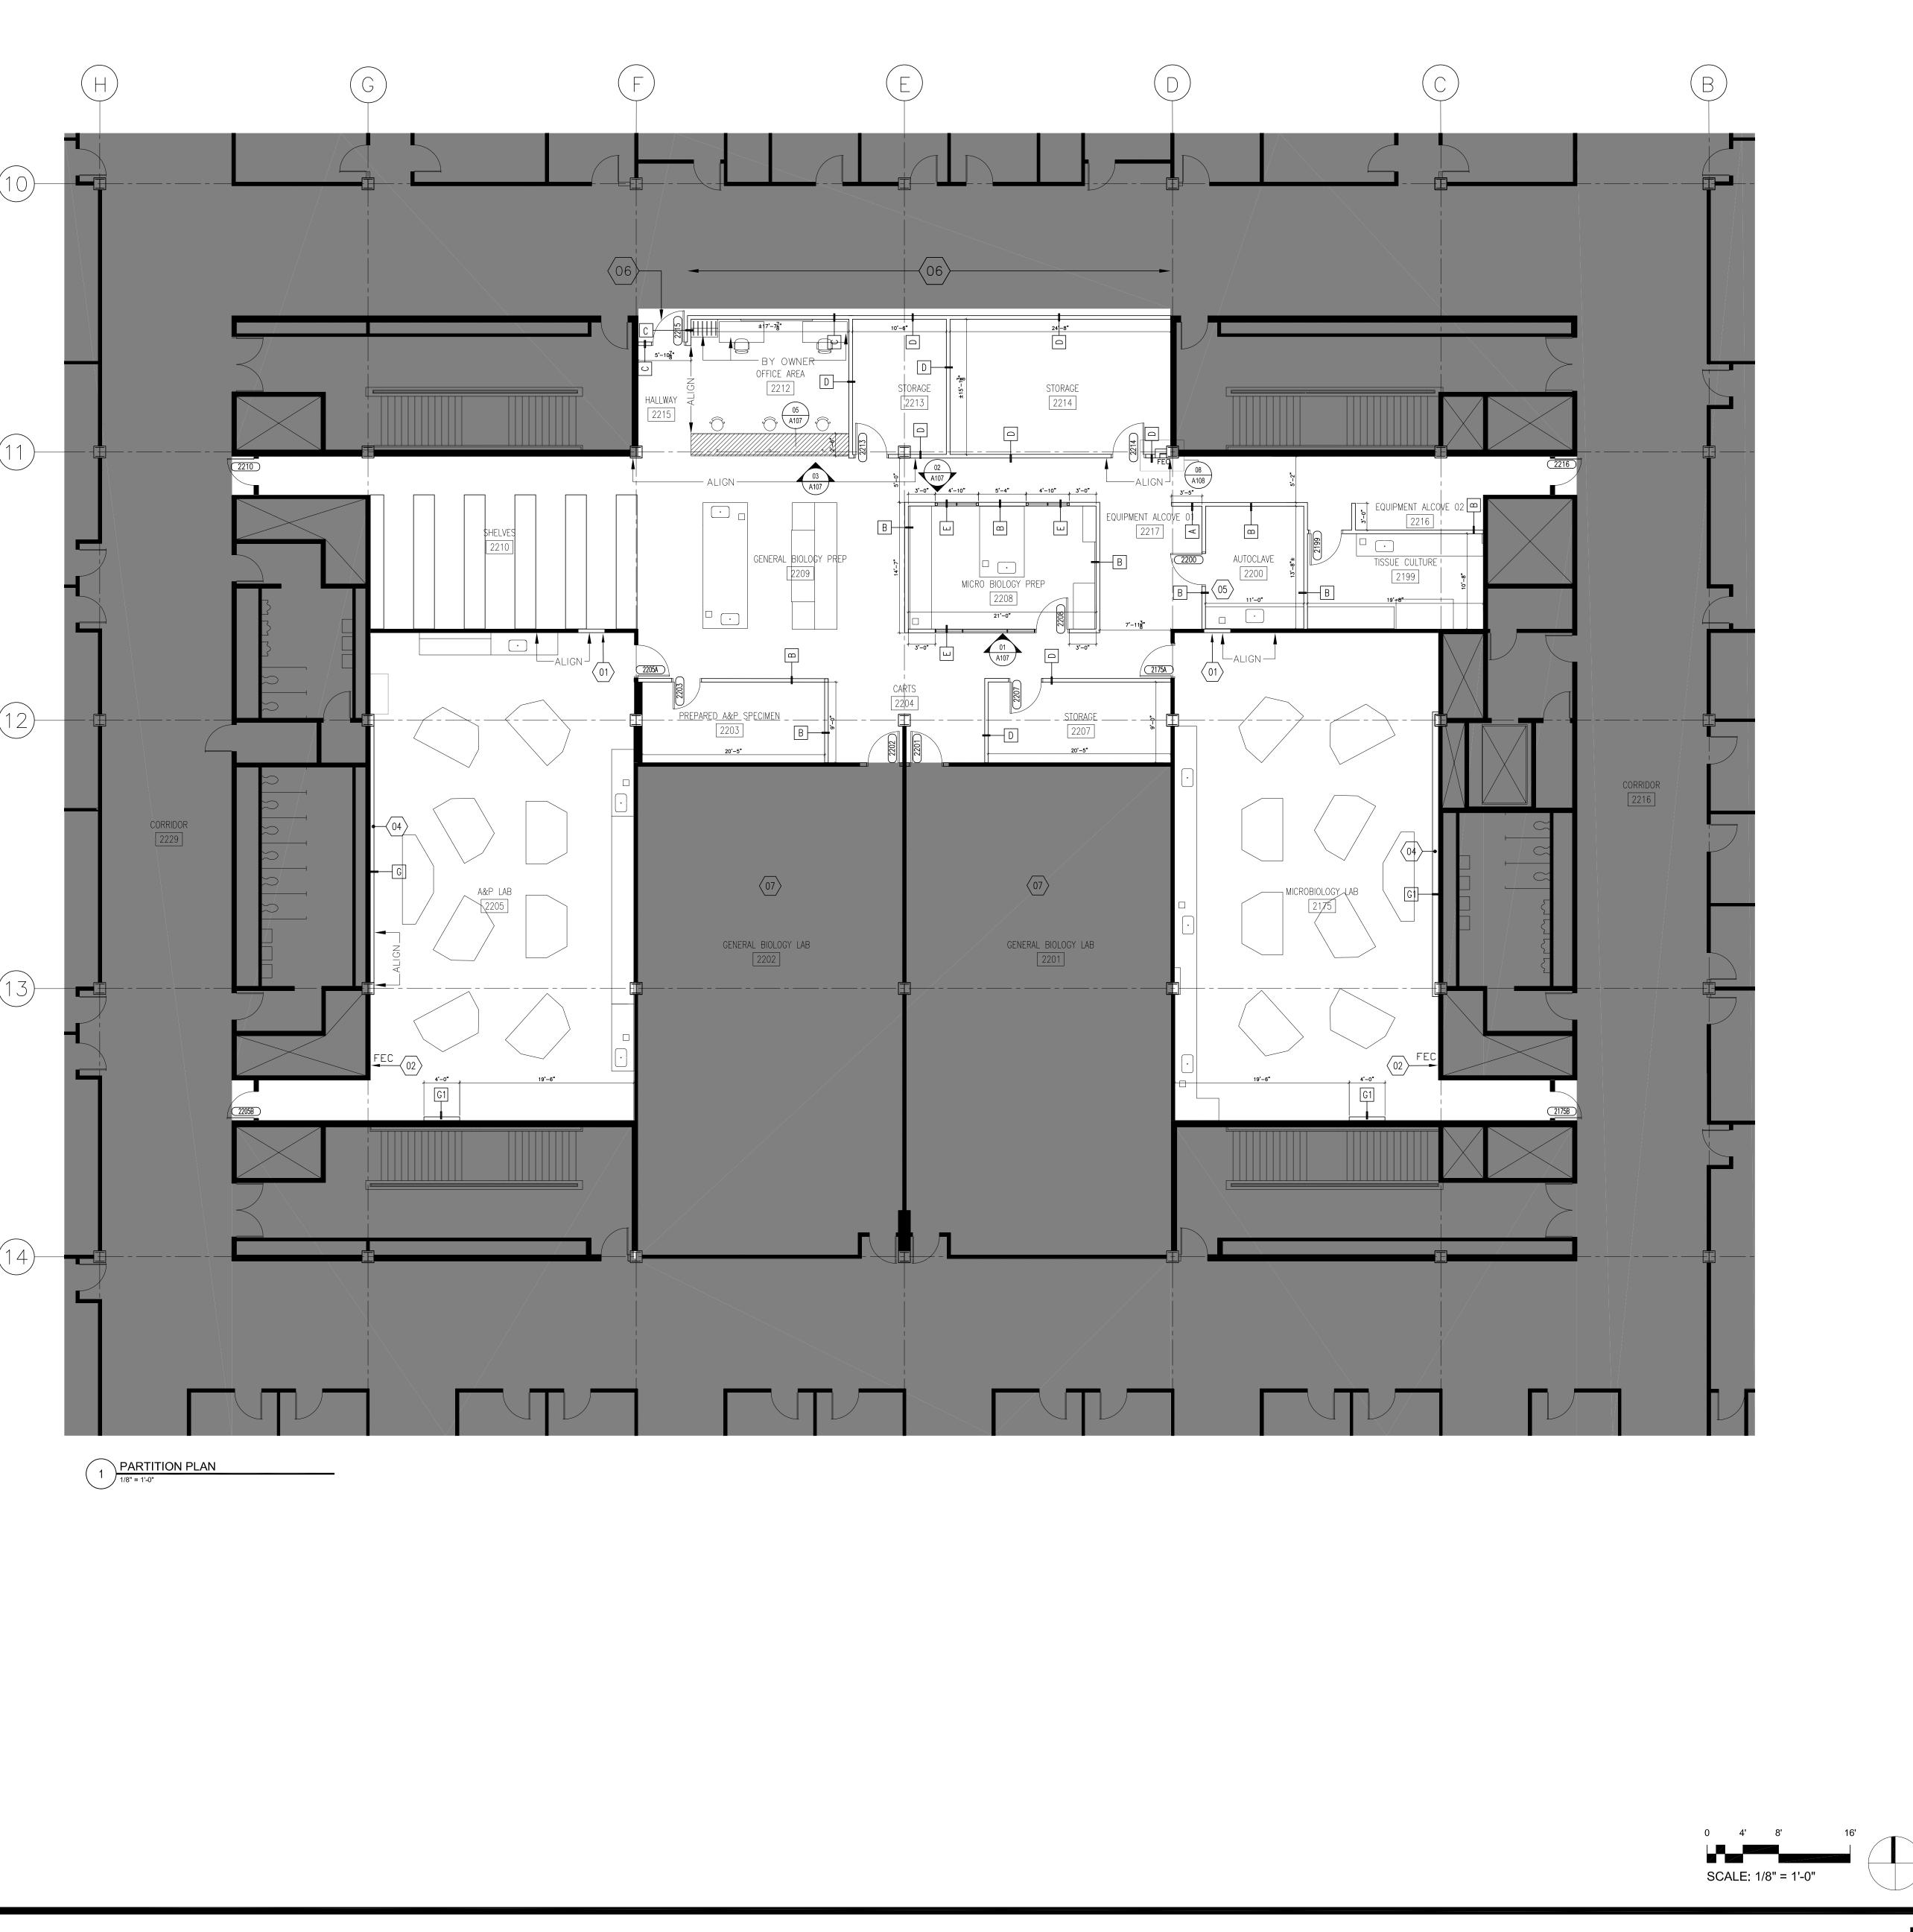

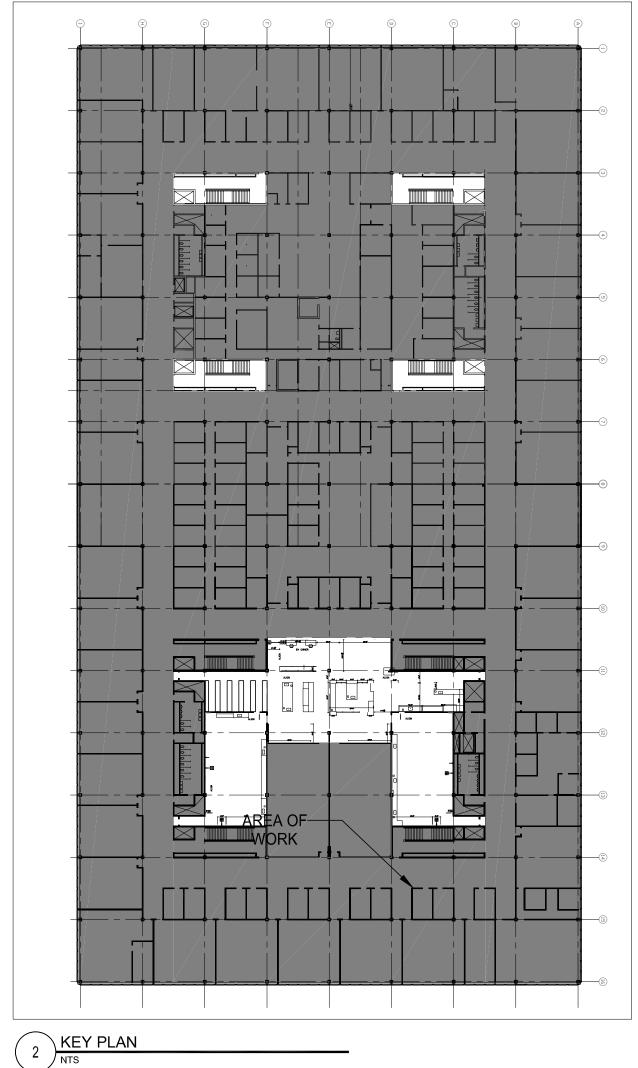

SECOND FLOOR PARTITION PLAN

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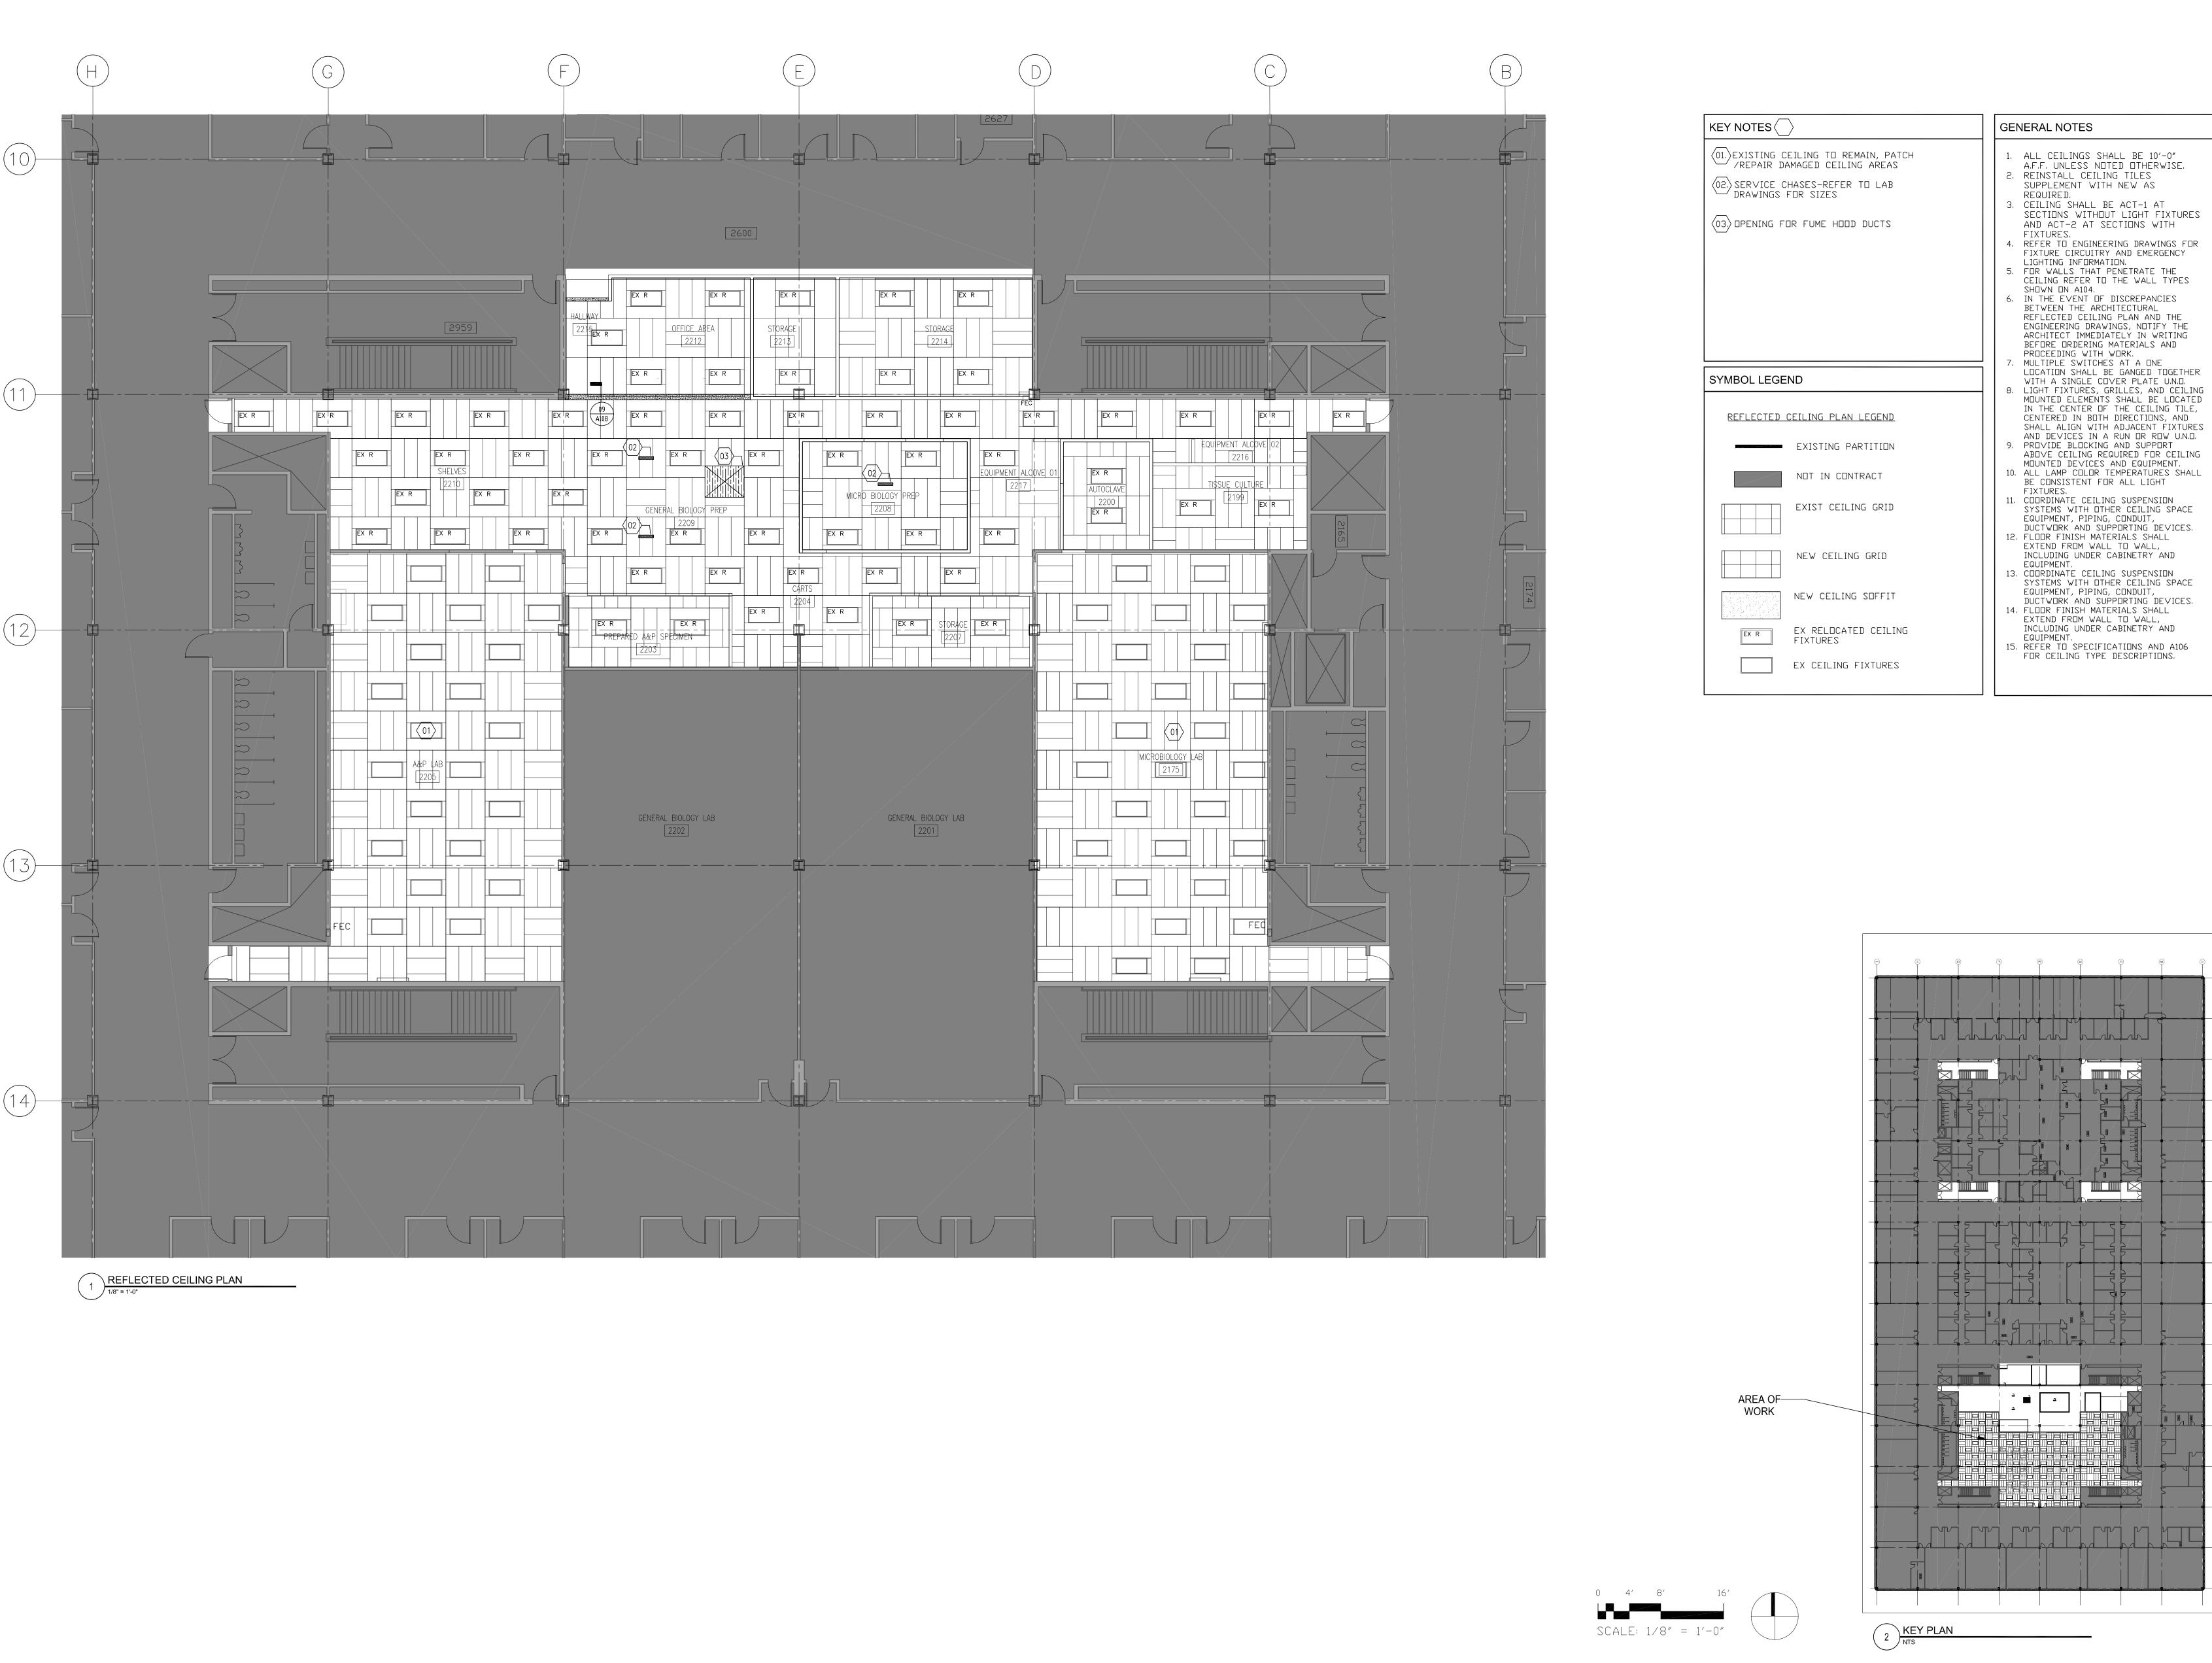
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15. REFER TO SPECIFICATIONS AND A106 FOR CEILING TYPE DESCRIPTIONS. 05/17/23 ISSUE FOR 50% CD 04/28/23 ISSUE FOR CLIENT

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SECOND FLOOR REFLECTED CEILING PLAN

CITY COLLEGES OF CHICAGO

-TRUMAN COLLEGE

PROJECT NUMBER:

PROJECT MANAGER:

ARCH/ENG:

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SCALE:

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NO. DATE REVISIONS/ISSUANCES


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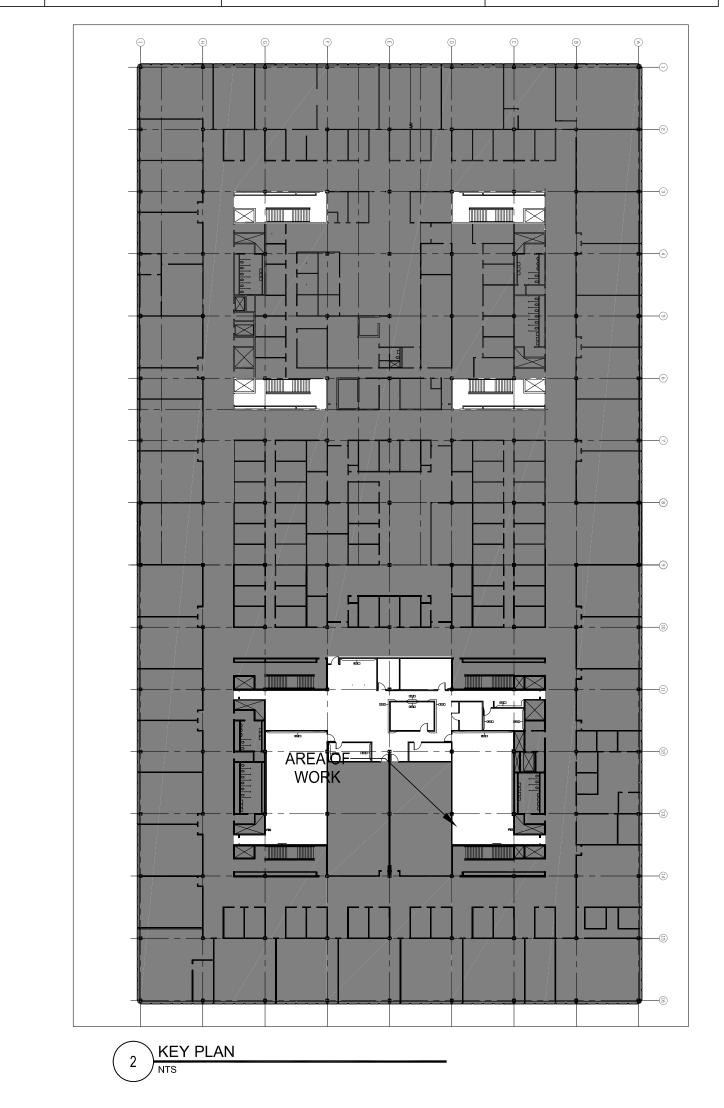


#### GENERAL NOTES

#### GENERAL NOTES

- 1. PREP AND REPAINT ALL EXIST. DOORS AND FRAMES TO REMAIN
- 2. ALL H.M. DOORS & FRAMES TO BE PAINTED P-3
  3. NOTIFY ARCHITECT OF DISCONTINUED OR UNAVAILABLE FINISHES AT THE EARLIEST OPPORTUNITY SO A
- SUBSTITUTION MAY BE SELECTED WITHOUT
  JEOPARDIZING THE CONSTRUCTION SCHEDULE,
  4. INSTALL ALL FINISH MATERIALS IN ACCORDANCE WITH
  THE MANUFACTURER'S RECOMMENDED SPECIFICATIONS,
- SURFACE PREPARATIONS, ADHESIVES AND BACKINGS, 5. REPAIR ALL UNEVEN FLOOR CONDITIONS FOR PROPER INSTALLATION OF NEW FLOORING MATERIALS.
- 6. ELECTRICAL SWITCH AND DUTLET COVER PLATES SHALL
- BE INSTALLED AFTER COMPLETION OF THE PAINTING.
  7. PROVIDE VINYL TRANSITION STRIPS AT ALL FLOORING
- MATERIAL CHANGES U.N.D. 8. ALL ELECTRICAL PANELS VISIBLE IN AREAS DTHER
- THAN ELECTRICAL CLOSETS SHALL BE PAINTED TO MATCH THE ADJACENT WALL.
- 9. FLOOR FINISH MATERIALS SHALL EXTEND FROM WALL TO WALL, INCLUDING UNDER CABINETRY AND EQUIPMENT.

		1		
TAG	DESCRIPTION	MANUFACTURER	FINISH / COLOR	REMARKS / NOTES
RF-1	RUBBER FLOORING	NORA	NORAPLAN ENVIRONCARE 3MM 7045 ICE SKATING	RUBBER SHEET
RB-1	RUBBER BASE	ROPPE	638 CADET	
P-1	BASE PAINT	SHERWIN WILLIAMS	COOL GREY MATCH B20W12651	
P-2	ACCENT PAINT	SHERWIN WILLIAMS	BLUEBIRD FEATHER SW 9062	
P-3	DOOR & FRAME PAINT	SHERWIN WILLIAMS	SW 6279 BLACK SWAN	
PL-1	PLASTIC LAMINATE	WILSONART	CRISP LINEN 4942-38 FINE VELVET FINISH	
ACT-1	ACOUSTIC CEILING TILE	ARMSTRONG	TO MATCH EXISTING MR87096 20IN X 60IN 3/4IN	GRID TO MATCH EXISTING
ACT-2	ACOUSTIC CEILING TILE	ARMSTRONG	TO MATCH EXISTING MR87097 18IN X 60IN 3/4'	GRID TO MATCH EXISTING
GL-1	CLEAR TEMPERED GLASS	_	3/8" THICK CLEAR	

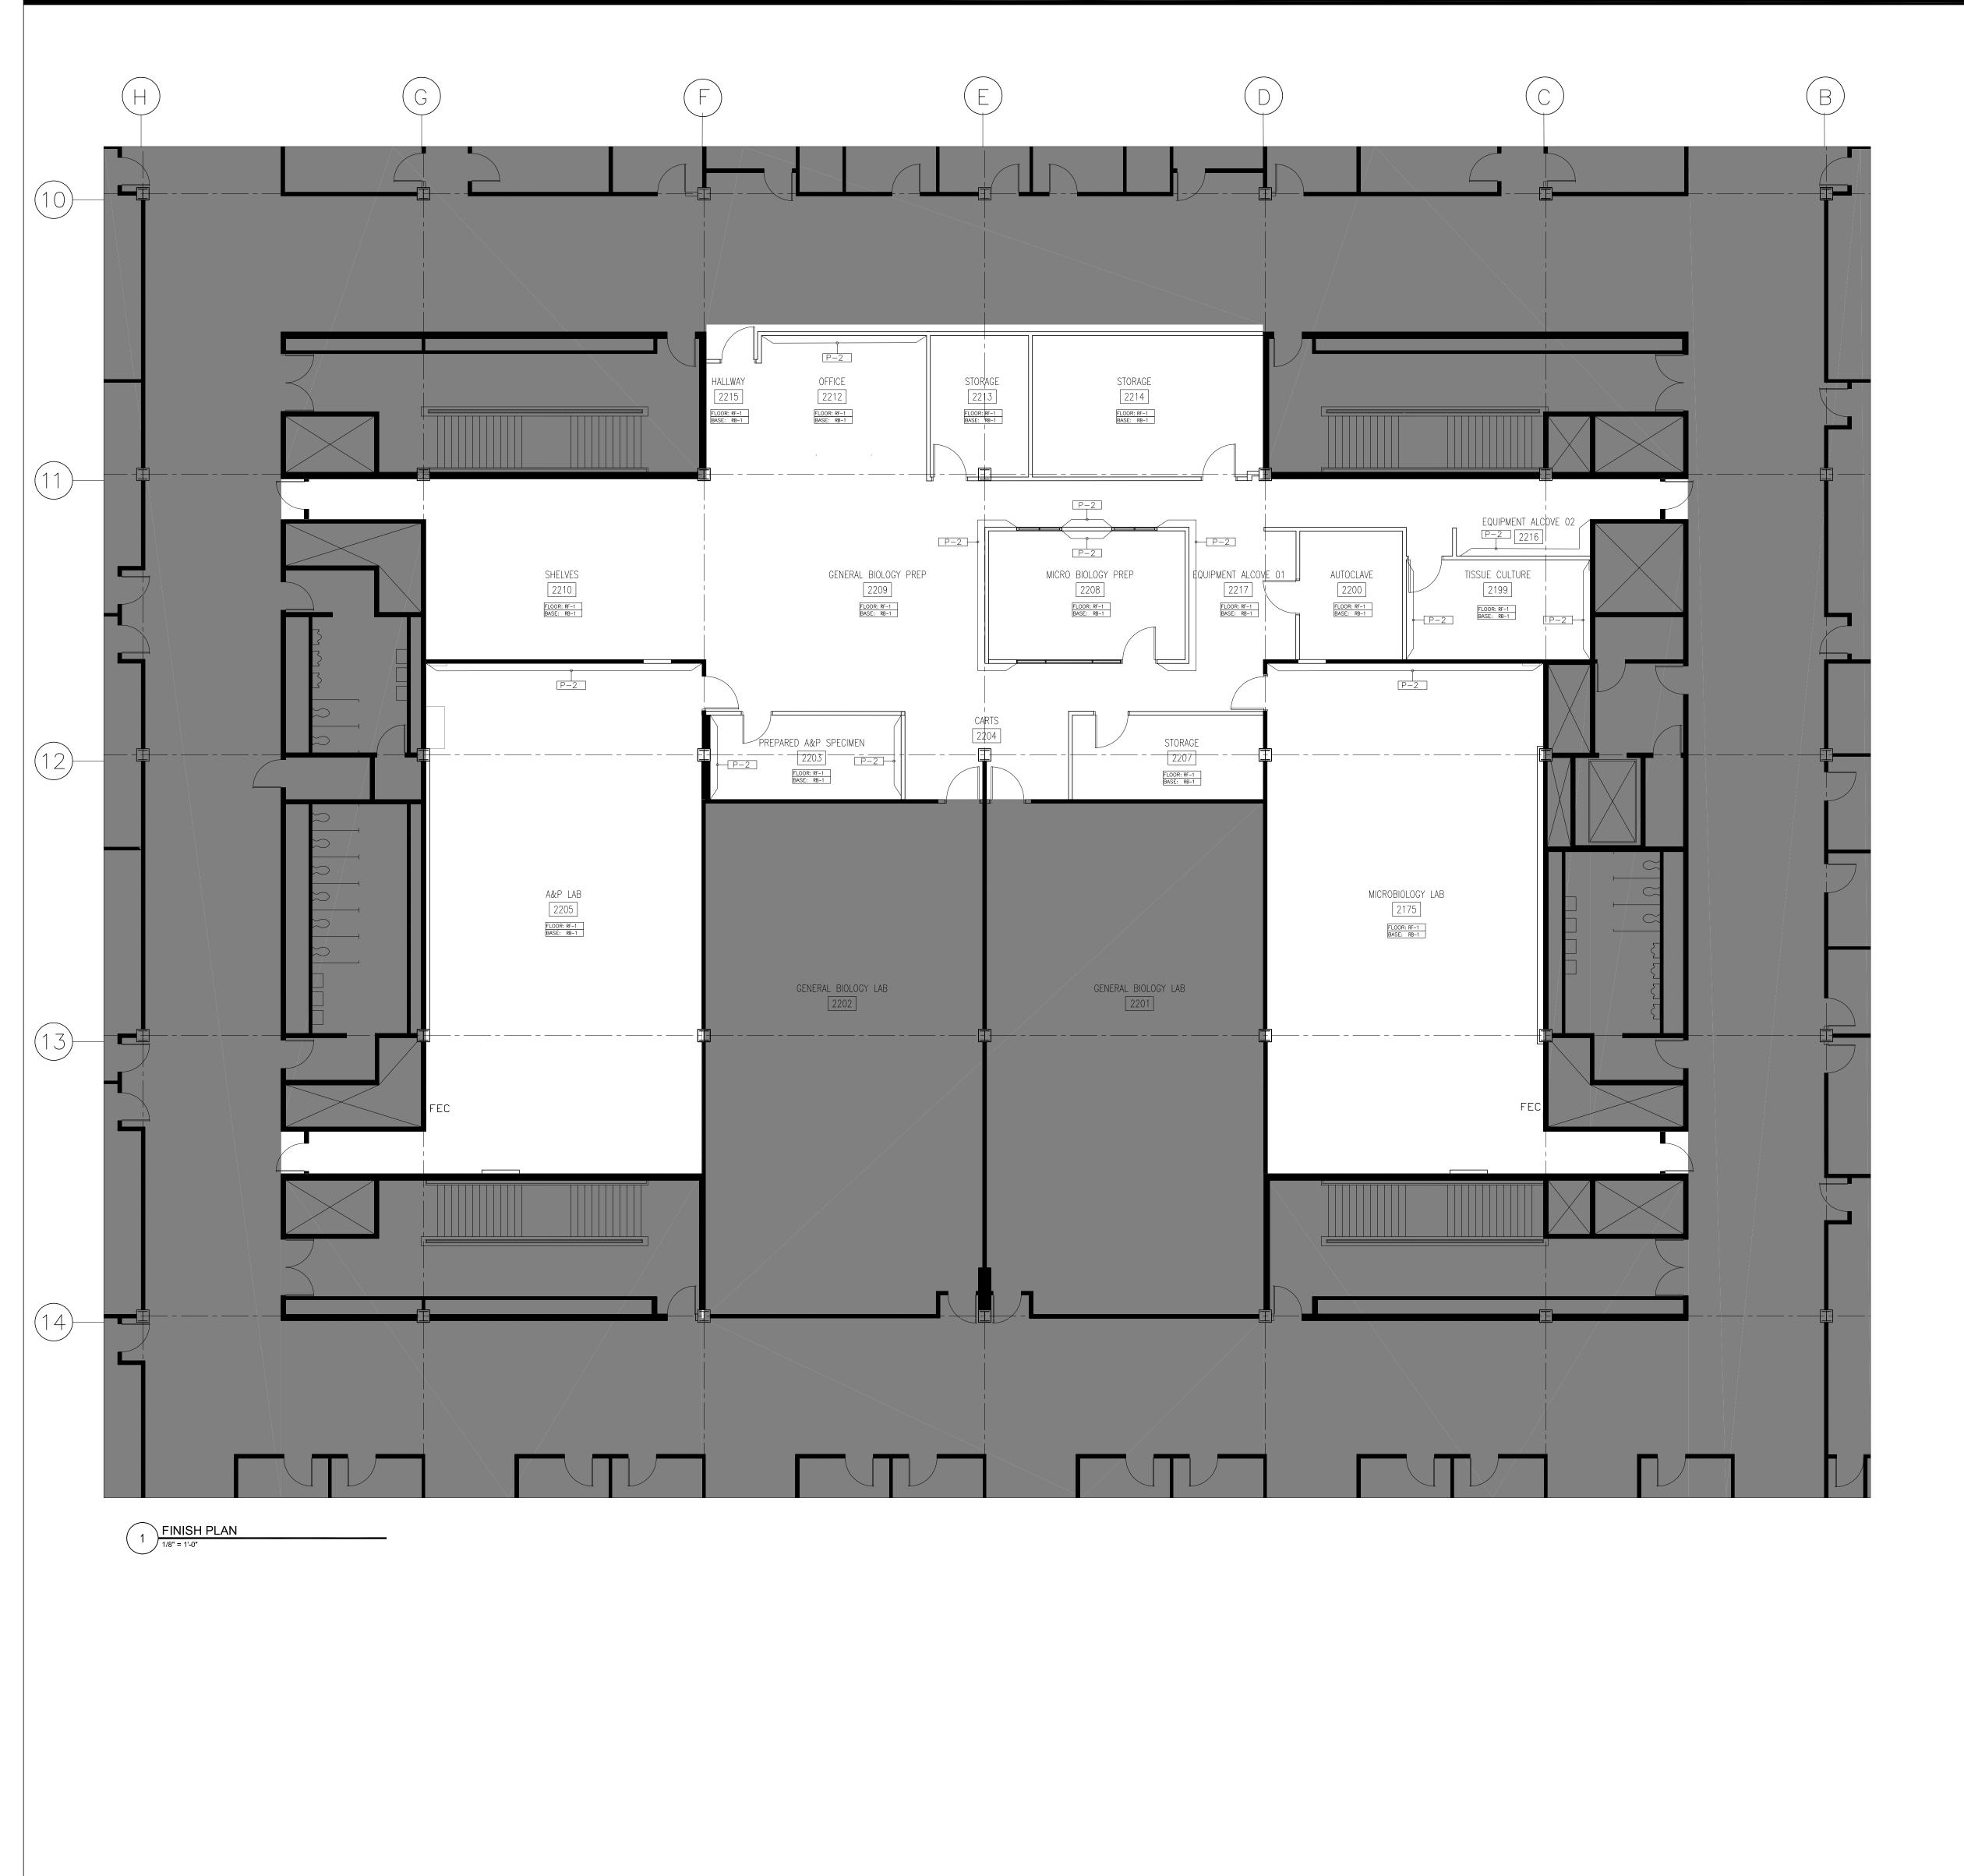

0 4' 8' 16' SCALE: 1/8" = 1'-0"

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-TRUMAN COLLEGE
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NO. DATE REVISIONS/ISSUANCES

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SCALE: 1/8" = 1'-0'

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SECOND FLOOR FINISH PLAN & LEGEND

A106

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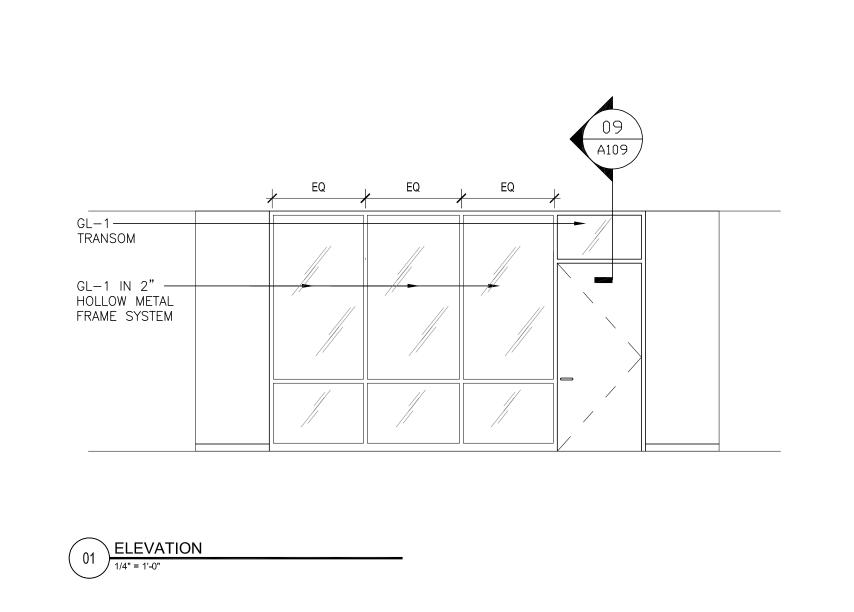
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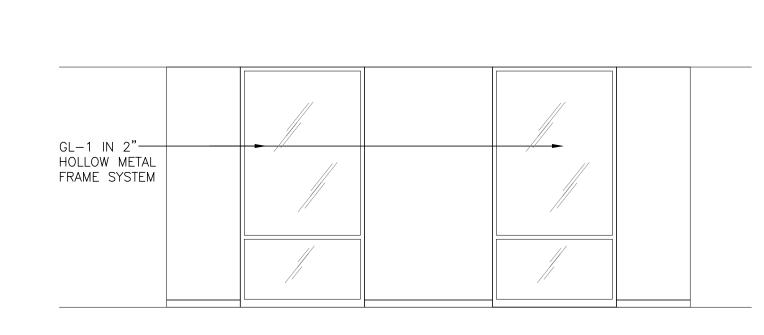
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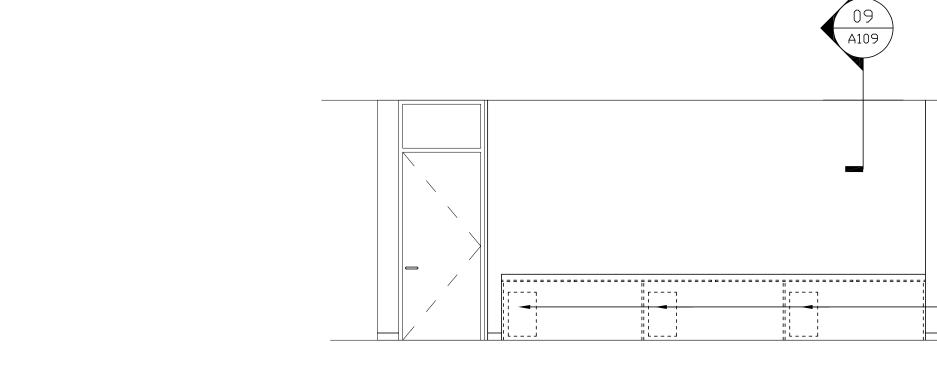
Architect of Record


Owner




07 MILLWORK DETAILS
1-1/2" = 1'-0"





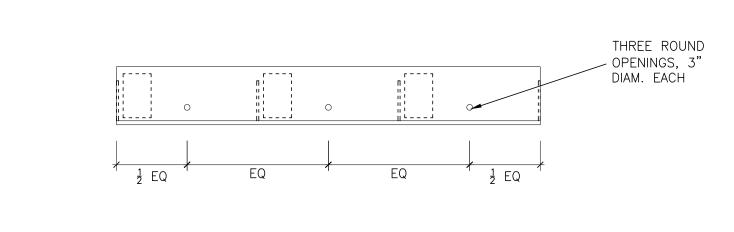

— MOBILE FURNITURE PEDESTALS BY OWNER

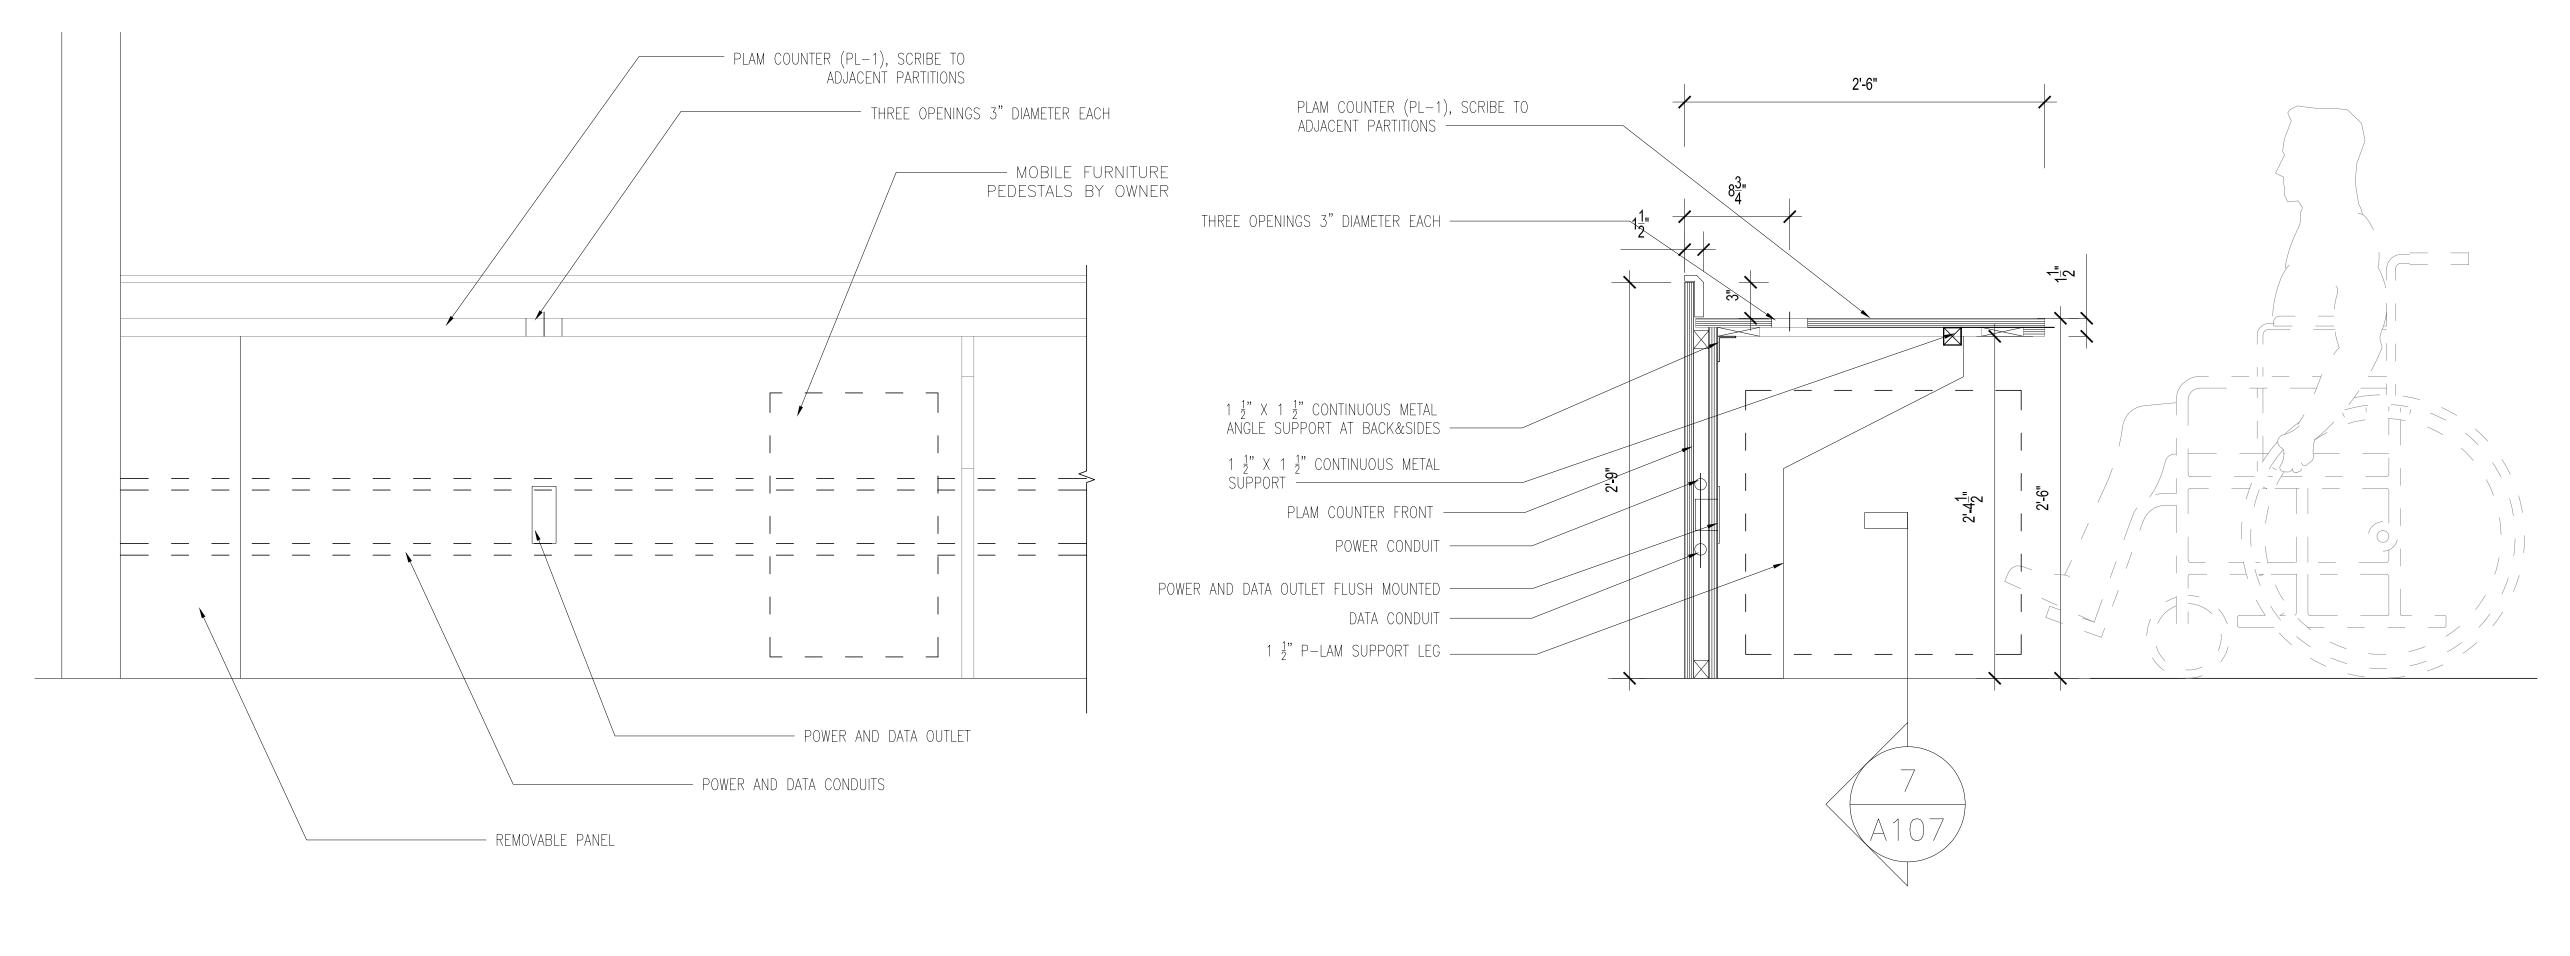

05 MILLWORK DETAILS
1-1/2" = 1'-0"

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PROJECT MANAGER: ARCH/ENG: SCALE:

AS SHOWN DRAWN BY: CHECKED BY:


> INTERIOR ELEVATIONS & MILLWORK DETAILS


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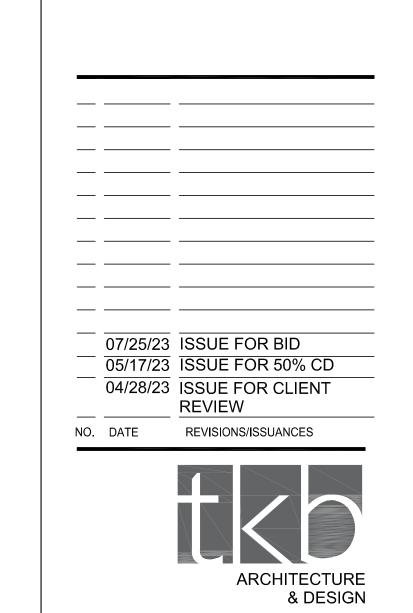
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1 1/2" = 1'-0'

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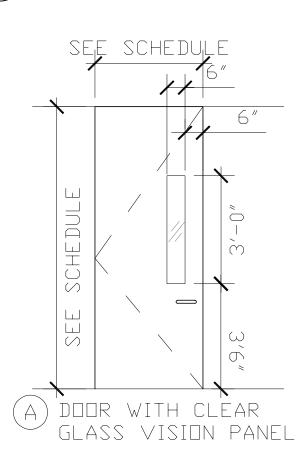
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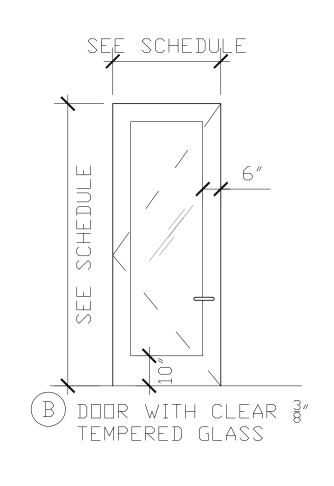
					DO	OR A	ND F	RAM	E SCH	IEDUL	_ <b>E</b>		Τ
	DOOR							FRAME			HARDWARE		
		SIZE	Ξ								FIRE RATING		NOTES
MARK	ROOM NAME	WD	HGT	TYPE	MATERIAL	GLAZING	FINISH	TYPE	MATERIAL FINISH		LABEL	SET NO	
2199	TISSUE CULTURE	3'-6"	7'-10"	A	H.M.	WIRED	PT-3	2	H.M.	PT-3	_	1	
2200	AUTOCLAVE	3'-6"	7'-10"	А	H.M.	WIRED	PT-3	2	H.M.	PT-3	_	1	<b>(D1)</b>
2201	GEN. BIOLOGY PREP	3'-6"	7'-10"	А	H.M.	WIRED	PT-3	2	H.M.	PT-3	_	1	
2202	GEN. BIOLOGY PREP	3'-6"	7'-10"	A	H.M.	WIRED	PT-3	2	H.M.	PT-3	_	1	
2203	PREPARED A&P SPECIMEN	3'-6"	7'-10"	A	H.M.	WIRED	PT-3	2	H.M.	PT-3	_	2	<b>(D1)</b>
2205A	A&P LAB	3'-6"	7'-10"	А	H.M.	WIRED	PT-3	2	H.M.	PT-3	-	1	
2205B	A&P LAB	EXISTING VIF	7'-10"	А	H.M.	WIRED	PT-3	_	EXIST	PT-3	С	4	EXISTING FRAME TO REMAIN
2207	STORAGE	3'-0"	7'-10"	С	H.M.	-	PT-3	1	H.M.	PT-3	В	3	
_	NOT USED	_	_	_	-	-	_	_	_	_	_	_	
2208	MICRO BIOLOGY PREP	3'-6"	7'-10"	В	H.M.	CLEAR TEMPERED	PT-3	1/A107	H.M.	PT-3	-	1	<b>(D1)</b>
2210	SHELVES	EXISTING VIF	7'-10"	А	H.M.	WIRED	PT-3	_	EXIST	PT-3	С	3	EXISTING FRAME TO REMAIN
2211	NOT USED	_	_	_	-	-	_	_	_	_	-	_	
2212A	NOT USED	_	_	_	_	_	_	_	_	_	_	_	
2212B	NOT USED	_	_	_	_	_	_	_	_	_	_	_	
2213	STORAGE	3'-6"	7'-10"	С	H.M.	_	PT-3	1	H.M.	PT-3	В	3	
2214	STORAGE	3'-6"	7'-10"	С	H.M.	_	PT-3	1	H.M.	PT-3	В	3	
2215	HALLWAY	3'-6"	7'-10"	А	H.M.	WIRED	PT-3	2	H.M.	PT-3	С	3	
2216	EQUIPMENT ALCOVE 02	EXISTING VIF	7'-10"	А	H.M.	WIRED	PT-3	_	EXIST	PT-3	С	3	EXISTING FRAME TO REMAIN
2175A	MICRO BIOLOGY LAB	3'-6"	7'-10"	A	H.M.	WIRED	PT-3	2	H.M.	PT-3	_	1	
2175B	MICRO BIOLOGY LAB	EXISTING VIF	7'-10"	A	H.M.	WIRED	PT-3	_	EXIST	PT-3	С	4	EXISTING FRAME TO REMAIN


HARDWARE SETS						
Set No. & Description	QTY.	HARDWARE SET NO				
Set 1 - PASSAGE, SINGLE DOOR	1	PASSAGE LEVERSET				
	2 PAIR	BUTT HINGES				
	1	FLOOR STOP				
	3	SILENCERS				
Set 2 - OFFICE LOCK, SINGLE DOOR	1	OFFICE FUNCTION LEVER LOCKS				
	2 PAIR	BUTT HINGES				
	1	FLOOR STOP				
	3	SILENCERS				
	1	CLOSER				
SET 3 - STORAGE LOCK, SINGLE DOOR	1	STOREROOM FUNCTION LEVER LO				
	2 PAIR	BUTT HINGES				
	1	FLOOR STOP				
	1	SURFACE MOUNTED CLOSER				
	3	SILENCERS				
	1	CLOSER				
SET 4 - CLASSROOM LOCK, SINGLE DOOR	1	CLASSROOM FUNCTION LEVER LOG				
	2 PAIR	BUTT HINGES				
	1	FLOOR STOP				
	3	SILENCERS				
	1	CLOSER				

**GENERAL NOTES** 1. ALL HOLLOW METAL FRAMES SHALL BE 2", FULLY WELDED. 2. UNDERCUT THE BOTTOMS OF THE DOORS TO CLEAR THE TOP OF THE FINISHED FLOOR BY ½ INCH MAXIMUM U.N.O. WHERE RADICAL VARIATIONS IN THE FLOOR LEVEL EXIST, DOORS SHALL BE ORDERED WITH BOTTOM STILE SIZED TO ACCOMMODATE THE UNDERCUT CONDITIONS. 3. AT HOLLOW METAL FRAMES, CAULK THE JOINT BETWEEN ALL SIDES OF THE FRAME AND WALL WITH PRINTABLE, LATEX CAULK TO MATCH WALL/FRAME COLOR. 4. CONTRACTOR SHALL COORDINATE KEYING WITH OWNER PRIOR TO FITTING CYLINDERS, KEY CYLINDERS TO OWNER'S MASTER. 5. AT EXISTING DOORS AND FRAMES TO REMAIN OR BE REUSED, REPAIR EXISTING DIVOTS, SCRATCHES AND OTHER DAMAGE PRIOR TO PAINTING. 6. WHERE DOORS ARE SCHEDULED FOR REUSE, CONTRACTOR SHALL IDENTIFY DOORS THAT CANNOT BE REPAIRED OR ARE NOT COMPATIBLE WITH NEW HARDWARE. 7. CONTRACTOR SHALL COORDINATE THE REUSE OF DOORS, FRAMES AND HARDWARE AND IDENTIFY RELOCATIONS ON THE DOOR/FRAME SUBMITTAL. 8. ALL DOORS SHALL REMAIN UNLOCKED IN THE DIRECTION OF EGRESS U.N.O.

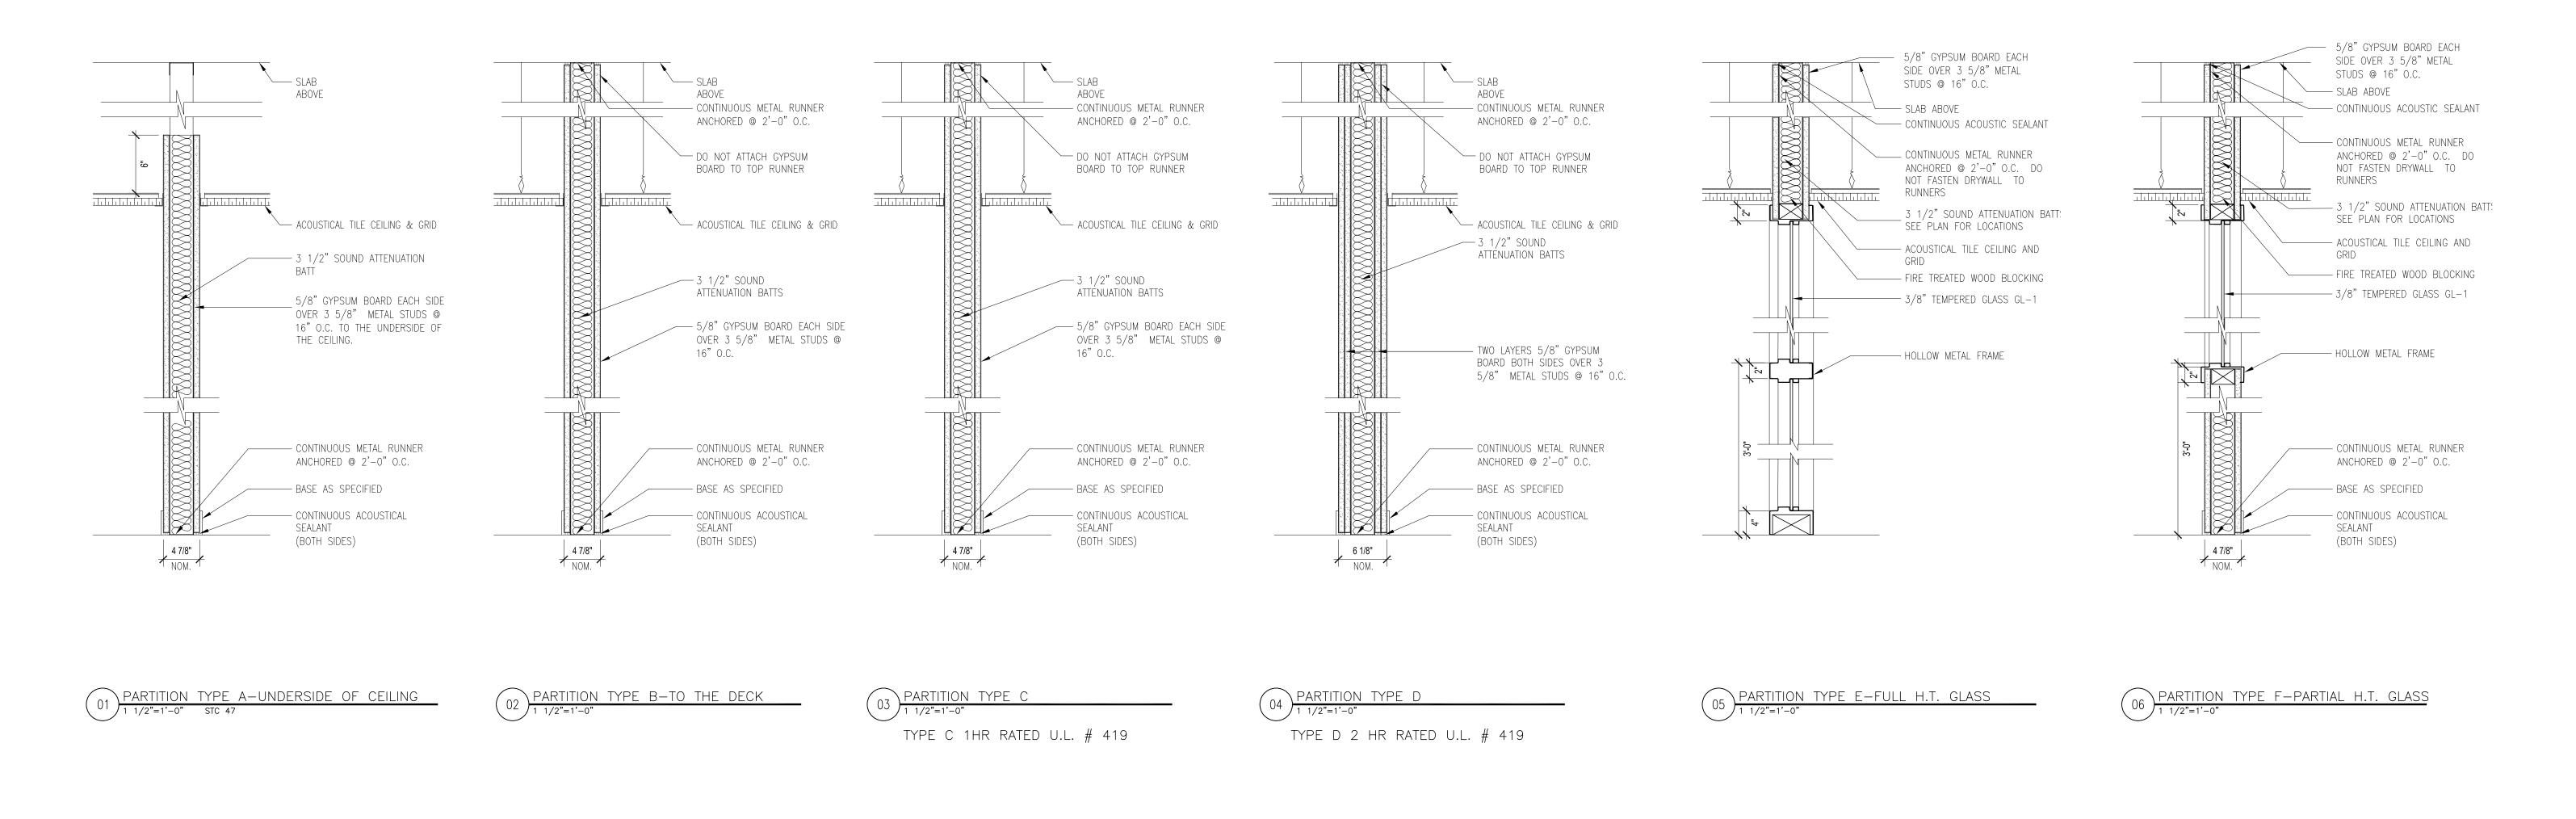
KEY NOTES D1) PROVIDE STOP MOUNTED FLEXIBLE, ADJUSTABLE SEAL GASKETS AT JAMBS & HEAD

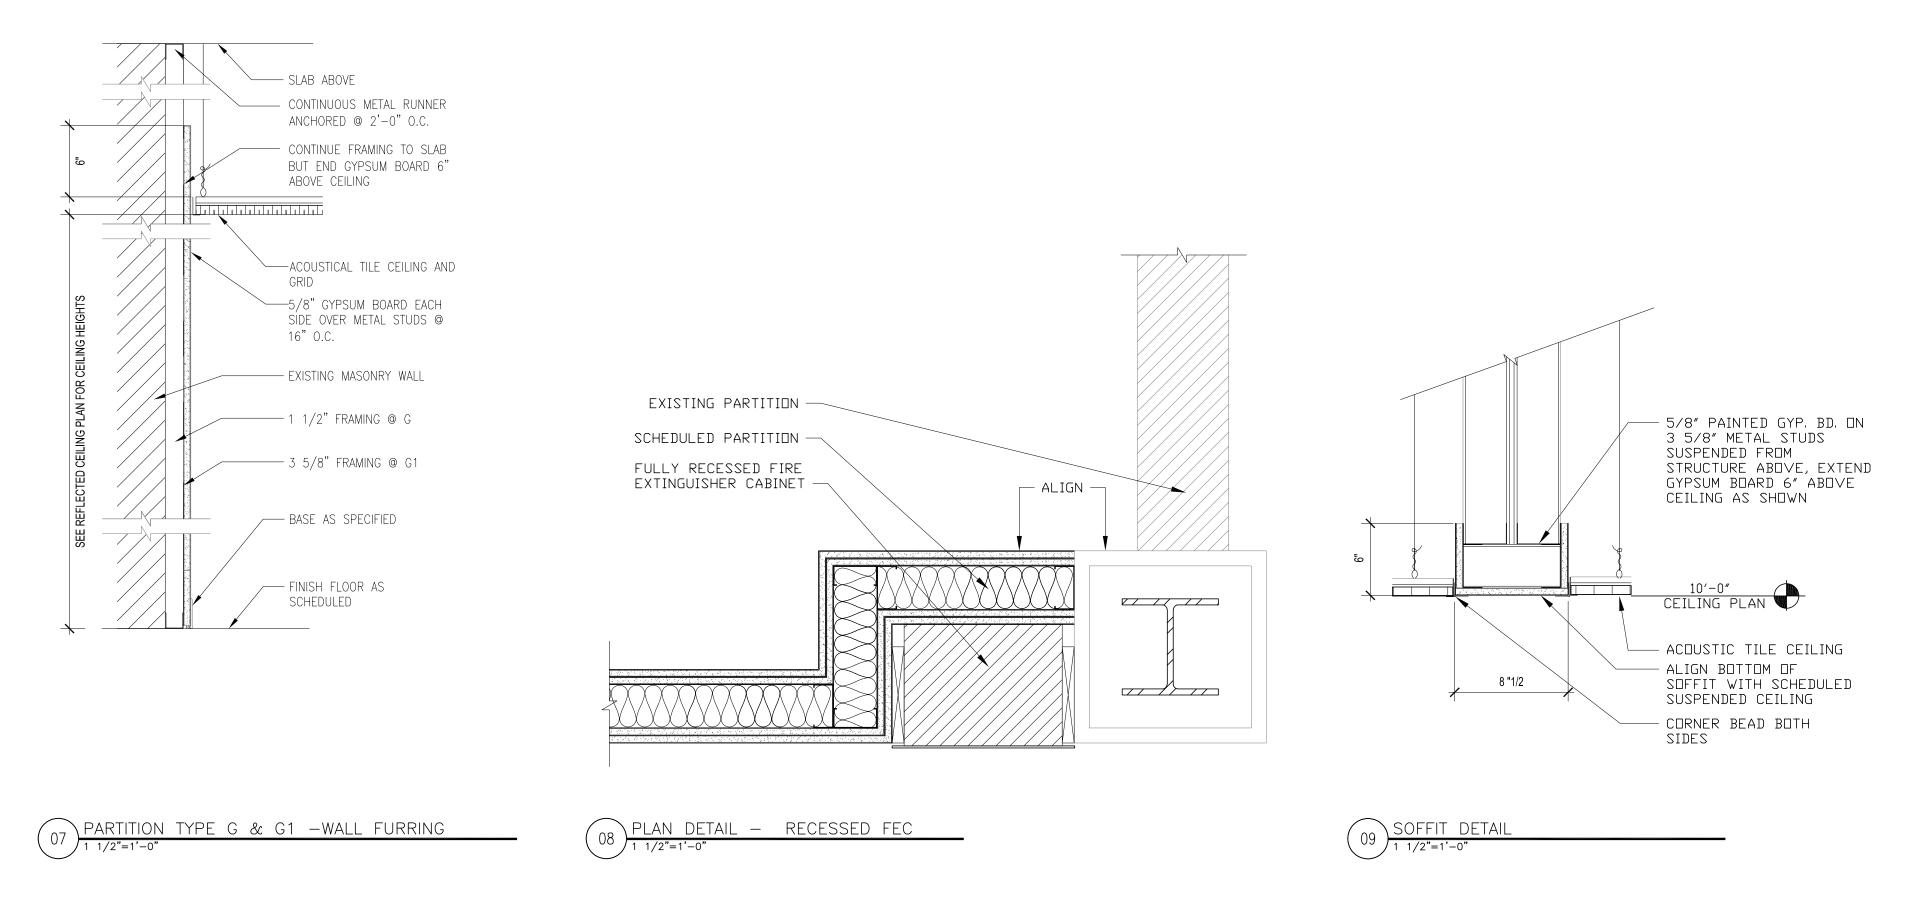





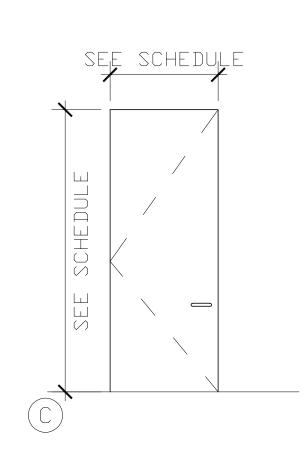



DOOR TYPES

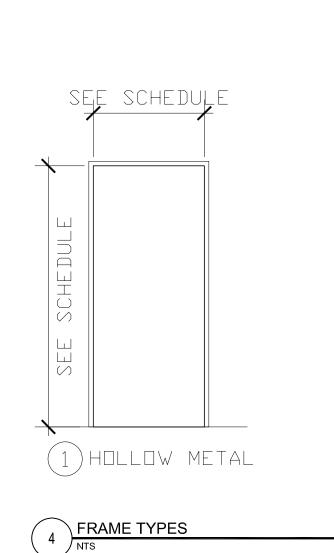


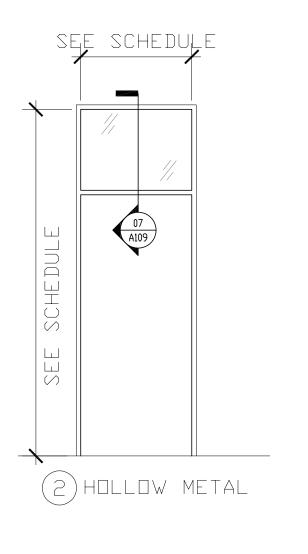

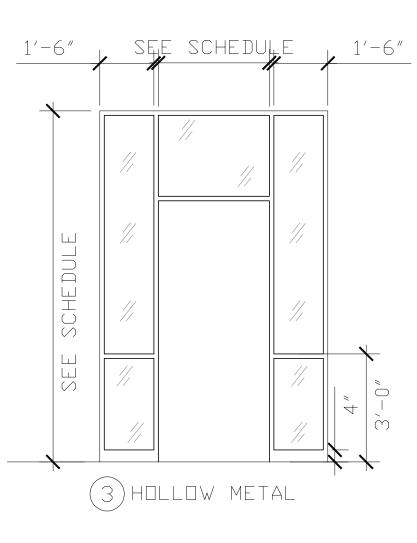

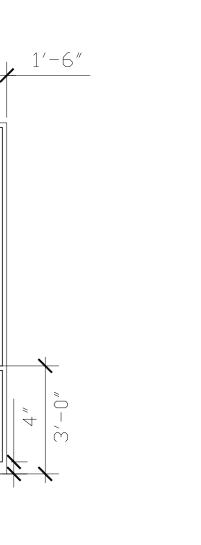


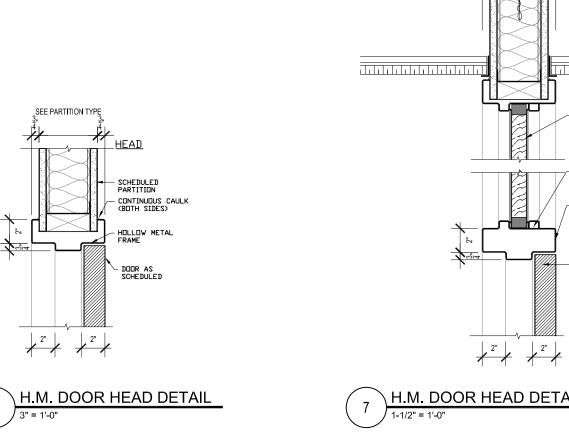


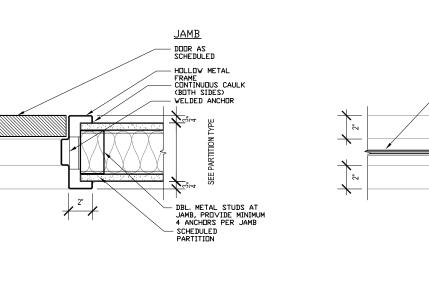




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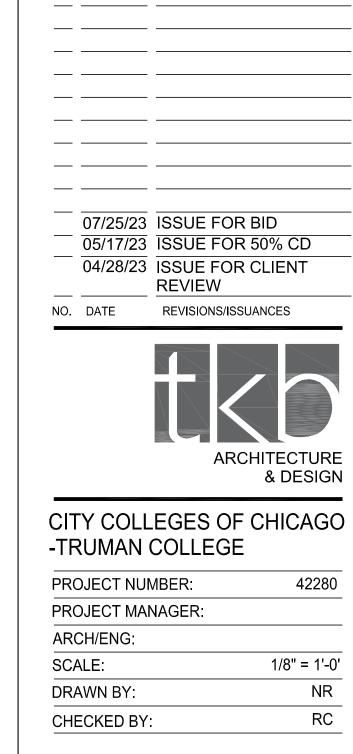


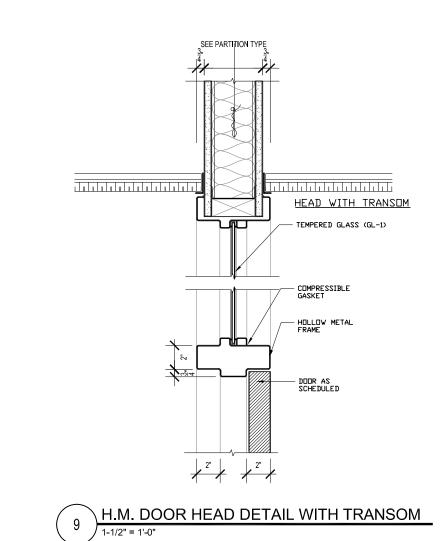

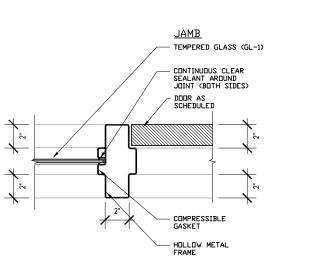HEAD WITH TRANSOM





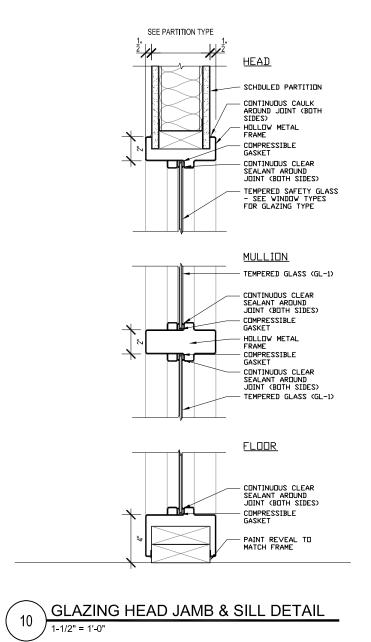

Lab Design Architect HOLABIRD & ROOT 140 S. Dearborn- Suite 500

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6 H.M. DOOR JAMB DETAIL


Environmental Engineer MEPFP Engineer Environmental Design International, Inc. 33 E Monroe Street #1825 Chicago, IL 60603 312.345.1400

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DOOR SCHEDULE & TYPES & **DETAILS** 

SEAL

							LAB	B EC	QUIPMEN	NT SCH	EDULE							
															ELECT			
						SIZE			NEW /			AB SERV			POW		EMERGENCY	
#	ITEM	MANUFACTURER	MODEL	QTY		D		OC.		DRAIN L	A LG	_V CO2			V	Α	POWER	RESP. REMARKS
01	AUTOCLAVE W/ REMOVEABLE S/S PANELS FRONT & SIDES	UNISTERI	Q19387	2			67"	F	NEW	Х			X	X	120V	14.5		0/0
02	AUDIO VISUAL SYSTEM EQUIPMENT RACK: WALL-MOUNTED	MIDDLE ATLANTIC	SBX-10	4			21" \	W	NEW									O/C TBD
03	AUDIO VISUAL USER EQUIPMENT RACK: INSIDE VENTED CABINET	MIDDLE ATLANTIC	SRSR-4-18	2				В	NEW									O/C TBD
	BONE BOX: SUITE CASE FOR A&P	-	-	6		10 ,	_		EXISTING			.,			400) (			
	BIO SAFETY CABINET	STERIGARD	-	1			39"		EXISTING		X	X			120V	-		O / C CO2 PIPED FROM CO2 TANKS OUTSIDE TISSUE CULTURE ROOM
06	CART	-	-				36"		EXISTING									0/C
07	CENTRIFUGE	EPPENDORF	5810R		28"				EXISTING						120V	10.8		O/C
08	48" FUME HOOD: CHEMICAL (ADA)	MOTT MANUFACTURING	NOVAGUARD	1	48"	31"   1	13"	В	NEW	X	X	X	X					C / C PROVIDE INTEGRAL ACCESSIBLE BASE; EXHAUST; SINGLE VERTICAL SASH; 18" MAX SASH HT; CONSTANT VOLUME W/ FAN ON/OFF SWITCH THAT IS COMBINED W/ HOOD LIGHT
09	48" FUME HOOD: CHEMICAL	MOTT MANUFACTURING	NOVAGUARD	1		31" 1	13"	В	NEW	Х	Х		X					C / C EXHAUST; SINGLE VERTICAL SASH; 18" MAX SASH HT; CONSTANT VOLUME W/ FAN ON/OFF SWITCH THAT IS COMBINED W/ HOOD LIGHT
10	FREEZER: -80 C	FISHER	IUE30086F	1	29"	31" 4	17"	F	FUTURE						120V	16		O / C REPLACES REVCO UTL390. 2ND IS FUTURE, NOT CURRENTLY OWNED
11	FREEZER: -20 C	KENMORE	ISOTEMP	1	33"	27" 6	66"	F	EXISTING						120V	16		
12	GAS TANK RACK (2 DEEP)	MATHESON	6532-2	1	30"	26" 3	30"	F	NEW									O / C CO2 TANKS PIPED TO TISSUE CULTURE ROOM
14	ICE MACHINE	SCOTTSMAN	-	1	26"	33" 3	39"	F	EXISTING	Х			Х		120V	-		O/C
15	INCUBATOR: TALL	BMT USA	INCUCELL 404	3	30"	32" 7	76"	В	NEW						115V	-		O / C CONFIRM TOTAL QUANTITY OF INCUBATORS
16	INCUBATOR	THERMOSCIENTIFIC	HERATHERM	2	25"	30" 3	38"	В	EXISTING						120V	-		O / C CONFIRM TOTAL QUANTITY OF INCUBATORS
17	INCUBATOR	THERMOSCIENTIFIC	MID140	1	24"	19" 1	19"	В	EXISTING						120V	-		O / C CONFIRM TOTAL QUANTITY OF INCUBATORS
18	LIQUID NITROGEN TANK ON WHEELS	LOCATOR	-	1	24"	24" 4	12"	F	EXISTING						120V	-		
20	MICROWAVE	PANASONIC	-	1	24"	19"   1	15"	В	EXISTING						120V	-		O/C
21	MICROWAVE	-	-	1	24"	19"   1	15"	В	EXISTING						120V	-		O/C
23	REFRIGERATOR: LAB	FISHER	ISOTEMP	2	32"	27" 6	35"	F	EXISTING						120V	-		O/C
24	REFRIGERATOR: LAB	LABLINE	-	1	28"	27" 6	32"	F	EXISTING						120V	-		O/C
25	REFRIGERATOR: LAB	WHIRLPOOL	-	1	34"	33" 6	66"	F	EXISTING									O / C CONFIRM TOTAL QUANTITY OF INCUBATORS
26	REFRIGERATOR: DELI (GLASS)	VWR	-	1	44"	23" 7	78"	F	EXISTING						120V	-		O/C
27	REFRIGERATOR: DELI (GLASS)	VWR	-	2	77"	31" 7	78"	F	EXISTING						120V	-		O/C
28	RO WATER POLISHER	-	-	1	24"	24" 5	54"	F	NEW	Х			Х		120V	-		O / C MODEL AND SIZE TO BE DETERMINED
29	STORAGE CABINET, FLAMMABLES, VENTED	JUSTRITE	899020	1	60"	42" 3	39"	F	NEW									O / C EXHAUST NEEDED; 90 GALS W/ SELF CLOSING DOORS
30	SHAKER H20	ENVIRON	LAB	1	23"	29" 2	23"	В	EXISTING						120V	5		O/C
31	SKELETON ON WHEELS: A&P	-	-	6	22"	22" 6	69"	F	EXISTING									
32	SPECIMEN TRAY	-	-	55	46"	18"	2"	В	EXISTING									O / C PROVIDE SHELF SPACE FOR MULTIPLE TRAYS @ 12" OC VERTICALLY
33	SLIDE TRAY BOX	-	-	3	9"	13" 1	12"	В	EXISTING									O/C
34	WATER BATH	FISHER	DIGITAL	2	25"	17" 1	15"	В	EXISTING						120V	8.5		O/C
35	WATER BATH	FISHER	ISOTEMP 2332	1	26"	18"	8"	В	EXISTING						120V	8.5		O/C

	LAB CASEWORK SCHEDULE	
TAG	DESCRIPTION	DIMENSIONS
JA01	BASE CABINET: DOUBLE: 2 DOORS, ACID/BASE, VENTED FROM BACKSIDE THROUGH FUME HOOD	34"H x 29"D x 48"W
SK1	SINK: SINGLE BASIN, DROP IN EPOXY (DURCON #D55)	25"W x 15"L x 10"D
SK1A	SINK: SINGLE BASIN, DROP IN EPOXY (DURCON #D56), ACCESSIBLE	25"W x 15"L x 4.8"D
SK2	SINK: SINGLE BASIN, DROP IN EPOXY (DURCON #03C)	12"W x 8"L x 8"D
SK3	SINK: SINGLE BASIN, DROP IN SST	28"W x 16"L x 12"D
TE01	BASE CABINET: DOUBLE: 2 DOORS & 1 ADJ. SHELF	34"H x 22"D x 30"W
TE02	BASE CABINET: DOUBLE: 2 DOORS & 1 ADJ. SHELF	34"H x 22"D x 36"W
TE03	BASE CABINET: DOUBLE: 2 DRWS (HALF), 2 DOORS & 1 ADJ. SHELF	34"H x 22"D x 36"W
TE04	BASE CABINET: DOUBLE: 2 DRWS (HALF), 2 DOORS & 1 ADJ. SHELF	34"H x 22"D x 42"W
	, ,	
TE05	BASE CABINET: DOUBLE: 6 DRWS (2 FULL & 4 HALF)	34"H x 22"D x 36"W
TE07	BASE CABINET: DOUBLE: A/V CABINET, 1 DOOR (24"), VENTED, 1 FIXED PANEL W/ AV CONTROL KNOCK OUT (COORD. W/ A/V SUPPLIER)	34"H x 22"D x 36"W
TE08	BASE CABINET: DOUBLE: KNEE SPACE W/ TOP RAIL	34"H x 22"D x 30"W
TE09	BASE CABINET: DOUBLE: KNEE SPACE W/ TOP RAIL	34"H x 22"D x 36"W
TE10	BASE CABINET: DOUBLE: KNEE SPACE W/ TOP RAIL AT SINK W/ REMOVEABLE PANEL	34"H x 22"D x 36"W
TE11	BASE CABINET: DOUBLE: KNEE SPACE W/ TOP RAIL AT SINK W/ REMOVEABLE PANEL	34"H x 22"D x 42"W
TE12	BASE CABINET: DOUBLE: OPEN & 2 ADJ. SHELVES	34"H x 16"D x 15"W
TE13	BASE CABINET: DOUBLE: SINK, 2 DOORS	34"H x 22"D x 36"W
TE14	BASE CABINET: DOUBLE: SINK, 2 DOORS	34"H x 22"D x 42"W
TE15	BASE CABINET: DOUBLE: SINK, 2 DOORS	34"H x 22"D x 45"W
	· · · · · · · · · · · · · · · · · · ·	
TE17	BASE CABINET: OPEN WASTE CONTAINER SPACE	34"H x 22"D x 14"W
TE18	BASE CABINET: OPEN WASTE CONTAINER SPACE	34"H x 22"D x 18"W
TE19	BASE CABINET: SINGLE, 1 DRW, 1 DOOR & 1 ADJ. SHELF	34"H x 16"D x 18"W
TE20	BASE CABINET: SINGLE: 1 DOOR & 1 ADJ. SHELF	34"H x 22"D x 12"W
TE21	BASE CABINET: OPEN BACKPACK STORAGE, 1 FIXED VERTICAL DIVIDER	34"H x 16"D x 36"W
TE22	BASE CABINET: SINGLE, 1 DRW, 1 DOOR & 1 ADJ. SHELF	34"H x 22"D x 18"W
TE23	BASE CABINET: SINGLE: 1 DRW, 1 DOOR & 1 ADJ. SHELF	34"H x 22"D x 24"W
TE24	BASE CABINET: SINGLE: 1 DRW, 1 DOOR & 1 ADJ. SHELF	34"H x 22"D x 27"W
TE25	BASE CABINET: SINGLE: 4 DRWS	34"H x 22"D x 24"W
TE26	BASE CABINET: SINGLE: SINK, 1 DOOR	34"H x 16"D x 18"W
TE27	BASE CABINET: SINGLE: SINK, 1 DOOR	34"H x 16"D x 18"W
TG02	UPPER CABINET: DOUBLE: 2 GLASS DOORS & 2 ADJ. SHELVES	30"H x 13"D x 36"W
TG03	UPPER CABINET: DOUBLE: 2 GLASS DOORS & 3 ADJ. SHELVES, ACCESSIBLE	48"H x 13"D x 36"W
TG04	UPPER CABINET: SINGLE: 1 GLASS DOOR & 3 ADJ. SHELVES, ACCESSIBLE	36"H x 13"D x 18"W
TG05	UPPER CABINET: OPEN FRONT	30"H x 13"D x 36"W
TH01	TALL CASE: DOUBLE: 2 GLASS DOORS & 5 ADJ. SHELVES	84"H x 22"D x 48"W
TH02	TALL CASE: DOUBLE: 2 GLASS DOORS UPPER W/ 2 ADJ. SHELVES, 2 SOLID DOORS BASE W/ 3 ADJ. SHELVES	84"H x 22"D x 36"W
TH03	TALL CASE: DOUBLE: 2 GLASS DOORS UPPER W/ 2 ADJ. SHELVES, OPEN BASE	84"H x 22"D x 36"W
TH04	TALL CASE: DOUBLE: 2 GLASS DOORS, VENTED	84"H x 18"D x 48"W
TH05	TALL CASE: DOUBLE: 2 SOLID DOORS & 1 FIXED SHELF	84"H x 22"D x 48"W
TH06	TALL CASE: DOUBLE: 2 SOLID DOORS & 2 COAT RACKS	84"H x 22"D x 30"W
TH07	TALL CASE: DOUBLE: 2 SOLID DOORS & 2 COAT RACKS	84"H x 22"D x 36"W
TH08	TALL CASE: DOUBLE: 2 SOLID DOORS & 2 COAT RACKS	84"H x 22"D x 42"W
TH09	TALL CASE: DOUBLE: 2 SOLID DOORS, SCOPE DIVIDERS (SCOPE CABINET, 12 CAPACITY) LOCKABLE	84"H x 22"D x 36"W
TH10	TALL CASE: OPEN: 5 ADJ. SHELVES	84"H x 14"D x 36"W
TH11	TALL CASE: OPEN: 5 ADJ. SHELVES	84"H x 14"D x 48"W
TH12	TALL CASE: OPEN: 5 ADJ. SHELVES	84"H x 18"D x 36"W
TH13	TALL CASE: OPEN: 5 ADJ. SHELVES	84"H x 18"D x 48"W
TH15	TALL CASE: SINGLE 1 GLASS DOOR & 5 ADJ. SHELVES	84"H x 22"D x 24"W
TM01	SHELVING: REAGENT W/ RETAINING LIP, 3 TIERED	36"H x 24"D (SEE DWGS FOR LENGTH)
VA01	SHELVING: WALL: ADJUSTABLE: 1 TIER	84"H x 14"D x 36"W
		84"H x 14"D x 36"W
VA02	SHELVING: WALL: ADJUSTABLE, 3 TIERS, SST	
VA03	SHELVING: WALL: ADJUSTABLE, 7 TIERS, PERFORATED SST	84"H x 20"D x 48"W
VA05	SHELVING: WALL: ADJUSTABLE, 7 TIERS, WOOD	84"H x 20"D x 36"W
VA06	SHELVING: WALL: ADJUSTABLE, 3 TIERS	36"H x 14"D x 30"L
VN01	PEGBOARD W/ DRIP TROUGH	36"H x 24"W
VN02	PEGBOARD W/ DRIP TROUGH & MOUNTING SPACE FOR SOAP DISPENSER: LEFT SIDE	36"H x 24"W
VN03	PEGBOARD W/ DRIP TROUGH & MOUNTING SPACE FOR SOAP DISPENSER: RIGHT SIDE	36"H x 24"W
VS	EPOXY RESIN TOP	30"D (U.N.O)
VT	EPOXY RESIN TOP W/ 4" BACKSPLASH, BACK AND SIDE WALLS	30"D (U.N.O)
VW	SST TOP W/ 4" BACKSPLASH, BACK AND SIDE WALLS	30"D (U.N.O)

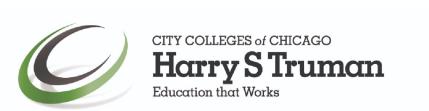ALTERNATE #3: PROVIDE STEEL CASEWORK IN LIEU OF WOOD CASEWORK IN THE MICROBIOLOGY LAB 2175, AND MICROBIOLOGY PREP LAB 2208

	LAB FIXTURE SCHEDULE	
TAG	DESCRIPTION	QTY
A1	AIR OUTLET, (1), DECK MOUNTED	1
CW1	COLD WATER OUTLET, WRIST BLADES, VACUUM BREAKER, AERATOR, SWIVEL	8
DI	DEIONIZED WATER FAUCET	4
E1	ELECTRICAL SERVICE PEDESTAL, SINGLE FACE, DOUBLE GANG, 4 OUTLETS	2
E2	ELECTRICAL SERVICE PEDESTAL, DOUBLE FACED, DOUBLE GANG, 8 OUTLETS, 2 CIRCUITS	18
ES	EMERGENCY SHOWER & EYEWASH, RECESSED WALL MOUNTED SAFETY STATION, EXPOSED CEILING-MOUNTED SHOWER HEAD	3
EW	EYE WASH, COUNTER MOUNTED	2
G1	GAS OUTLET, (1), DECK MOUNTED	1
G2	GAS OUTLET, (2) AT 90 DEGREE, DECK MOUNTED	17
G3	GAS OUTLET, (2) AT 180 DEGREE, DECK MOUNTED	2
HCW1	HOT & COLD WATER MIXING OUTLET, WRIST BLADES, VACUUM BREAKER, AERATOR, SWIVEL	8
HCW2	HOT & COLD WATER MIXING OUTLET, FOOT CONTROL, VACUUM BREAKER, AERATOR	4
HCW3	HOT & COLD WATER MIXING OUTLET, DECK MOUNTED, SINGLE SPOUT, W/ FLEXIBLE NECK W/ SPRING	1
V1	VACUUM OUTLET, (1), DECK MOUNTED	1
V3	VACUUM OUTLET, (2) AT 180 DEGREE, DECK MOUNTED	1

	LAB ACCESSORY SCHED	ULE		
TAG	DESCRIPTION	DIMENSIONS	QTY	RESP.
BH01	BAG HOOK, SINGLE, SST	-	64	C/C
CH01	COAT HOOK PANEL, SST W/ INDIVIDUAL SST HOOKS, 11 CAPACITY	5'-0"W x 1'-2"H	6	C/C
MB01	MARKERBOARD	7'-7"W x 4'-0"H	4	O/C
MB02	MARKERBOARD	4'-0"W x 4'-0"H	3	O/C
SC01	SHOWER CURTAIN & ROD	3'-10"W x 4'-0"D	3	C/C
WC01	WASTE CONTAINER	-	11	0/0
WC02	BIOHAZARD WASTE CONTAINER	-	4	0/0

#### SCHEDULE ABBREVIATIONS FOR LABORATORY EQUIPMENT

<u>SIZE</u>		ELECTRIC	CAL POWER
W D	WIDTH DEPTH	V A	VOLTAGE AMPERAGE
Н	HEIGHT		
LAB SER	<u>VICES</u>	<u>LOC. = LO</u>	<u>DCATION</u>
LA	LAB AIR	F	FLOOR
LG	LAB GAS	В	BENCH TOP
LV	LAB VACUUM	W	WALL
CW	COLD WATER		
HW	HOT WATER		
DI	DEIONIZED WATER		

#### RESP. = RESPONSIBILITY

Structural Engineer

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C/C CONTRACTOR FURNISHED / CONTRACTOR INSTALLED

Environmental Engineer MEPFP Engineer Architect of Record


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CITY COLLEGES of CHICAGO Harry S Truman

GENERAL SYMBOL LIST



#### SEE EQPT SCHEDULE FOR SERVICE RQT'S SYMBOL LIST FOR LABORATORY ACCESSORIES

**ACCESSORY TARGET** ACCESSORY CATEGORY (SEE ACCESSORY CATEGORY KEY) XX## ITEM NUMBER ITEM NUMBER (SEE EQUIPMENT SCHEDULE) (SEE ACCESSORY SCHEDULE)

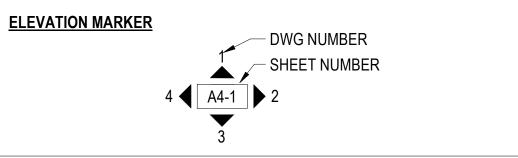**ACCESSORY CATEGORY KEY** 

SEE EQUIPMENT SCHEDULE & SPECIFICATIONS FOR FULL DESCRIPTION OF LABORATORY EQUIPMENT & ALL ASSOCIATED SERVICE RQT'S

FUME HOOD -

**BIO SAFETY CABINET** 


SEE EQPT SCHEDULE FOR SERVICE RQT'S

# SYMBOL LIST FOR

SYMBOL LIST FOR


**EQUIPMENT TARGET** 

LABORATORY EQUIPMENT

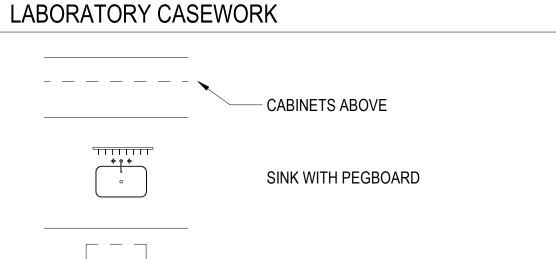

CASEWORK WITH KNEE SPACE BELOW

# **CASEWORK TARGET**

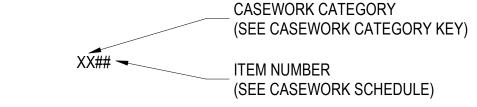

#### **CASEWORK CATEGORY KEY**

KS

WOOD, CHEMICAL FUME HOOD 34"H BASE CABINET SERIES SINK

WOOD, 34" H BASE CABINET SERIES WOOD, 30" H WALL CABINET SERIES (OVERHEAD)

WALL MOUNTED SHELVING UNITS

WOOD, FULL HEIGHT CABINET SERIES

FLAMMABLE STORAGE CABINETS **PEGBOARDS** 

EPOXY RESIN TOP - NO BACKSPLASH EPOXY RESIN TOP - 4" BACKSPLASH STAINLESS STEEL TOP WITH BACKSPLASH

FILLER PANEL (TO MATCH ADJACENT MATERIALS) KNEE SPACE WASTE HOLE IN COUNTERTOP WASTE CONTAINER SLOT

SEE CASEWORK SCHEDULE, PLUMBING DRAWINGS & SPECIFICATIONS FOR FULL DESCRIPTION OF LABORATORY CASEWORK

#### SYMBOL LIST FOR LABORATORY FIXTURES

#### FIXTURE TARGET FIXTURE CATEGORY (SEE FIXTURE CATEGORY KEY) ITEM NUMBER (SEE FIXTURE SCHEDULE)

#### FIXTURE CATEGORY KEY

ELECTRICAL SERVICE PEDESTAL GAS OUTLET AIR OUTLET VACUUM OUTLET COLD WATER OUTLET

HCW HOT AND COLD WATER MIXING OUTLET DEIONIZED WATER OUTLET

EYEWASH, COUNTER MOUNTED COMBINATION EMERGENCY SHOWER/EYEWASH

SEE FIXTURE SCHEDULE, SPECIFICATIONS, & MEP DRAWINGS FOR FULL DESCRIPTION OF MECHANICAL, PLUMBING & ELECTRICAL SERVICE FIXTURES

# HOLABIRD & ROOT

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GENERAL NOTES FOR LABORATORY FURNISHINGS

THE FOLLOWING NOTES APPLY TO SHEETS LF1-1 THROUGH LF3-2:

**BAG HOOKS** 

COAT HOOKS

MARKERBOARD (SEE ARCH SPEC)

SEE ACCESSORY SCHEDULE & SPECIFICATIONS FOR

FULL DESCRIPTION OF LABORATORY ACCESSORIES

SHOWER CURTAIN & ROD

WASTE CONTAINER

1. EQUIPMENT ITEMS DRAWN WITH SOLID LINES ON THE PLANS ARE TO BE PART OF THE CONSTRUCTION CONTRACT.

2. LABORATORY APPARATUS AND OTHER N.I.C. EQUIPMENT IS SHOWN BY DASHED LINE ( - - - - ). SUCH EQUIPMENT IS SHOWN TO PROVIDE LOCATION INFORMATION FOR ASSOCIATED UTILITY SERVICES AND TO CLARIFY DESIGN INTENT ONLY.

3. CLASSROOM FURNITURE AND CHAIRS N.I.C. ARE SHOWN AS HALFTONE, FOR COORDINATION AND INFORMATION ONLY.

4. DIMENSIONS SHOWN ON DRAWINGS "LF" ARE FOR CASEWORK AND EQUIPMENT LAYOUT, AND FOR COORDINATION ONLY. SEE ARCHITECTURAL PLANS FOR BUILDING DIMENSIONS.

5. STRUT ASSEMBLIES FOR UTILITY CHASES ARE TO BE INSTALLED BEFORE REMAINING CASEWORK TO EXPEDITE THE WORK.

6 INVESTIGATE MOUNTING CONDITIONS FOR WALL CASES AND PROVIDE APPROPRIATE HARDWARE AND ACCESSORIES FOR EACH CONDITION ENCOUNTERED.

7. ALL DIMENSIONS ON LABORATORY EQUIPMENT PLANS ARE TO BE VERIFIED IN FIELD (V.I.F.) BY CONTRACTOR.

8. WHEN CASEWORK IS LOCATED FROM WALL-TO-WALL THE FILLER PANEL AT EACH END SHOULD BE EQUAL SIZE.

9. ALL LABORATORY TOPS TO BE "VT" EPOXY-RESIN TOP WITH 4" HIGH BACKSPLASH (U.N.O.) EXCEPTIONS ARE DESIGNATED ON ELEVATIONS.

10. CASEWORK INDIVIDUAL DESIGNATIONS ARE SHOWN ON THE DRAWINGS FOR LOCATION WITHIN ASSEMBLIES AND TO ESTABLISH GENERAL CONFIGURATION. REFER TO SPECIFICATIONS FOR DESCRIPTIONS OF ALPHANUMERICALLY DESIGNATED ITEMS. REFER TO DRAWINGS LF1-1 THRU LF3-3 FOR DETAILS, TYPICAL ELEVATIONS AND SECTIONS.

11. CONTRACTOR SHOP DRAWINGS TO SHOW ANY JOINTS AT COUNTERTOPS AND REAGENT SHELVING.

12. FOR VENTED STORAGE CABINETS INDICATED, CONTRACTOR SHOP DRAWINGS TO IDENTIFY CENTERLINE LOCATION OF EXHAUST VENT CONNECTION RELATIVE TO NEARBY EXISTING CONSTRUCTION FOR COORDINATION WITH OTHER TRADES.

13. WHEN CASEWORK IS LOCATED FROM WALL-TO-WALL, VERIFY FIELD DIMENSIONS.

14. WHENEVER "VERIFY" IS INDICATED ON DRAWINGS IT MEANS "VERIFY IN FIELD BY CONTRACTOR".

15. ASSEMBLY OF ITEMS INTO LARGER UNITS SHALL FOLLOW TYPICAL CONFIGURATIONS SHOWN IN THE DETAILS ON DRAWINGS LF1-1 THRU

LF1-4 OR SHALL BE MANUFACTURER'S TYPICAL ASSEMBLY WHERE NOT SPECIFICALLY DETAILED. 16. SEE DETAILS ON DRAWINGS LF1-3 THRU LF1-4 TO DETERMINE SPACING OF INDIVIDUAL FIXTURES WITHIN SERVICE CLUSTER. DIMENSIONS SHOWN ON

LABORATORY EQUIPMENT PLANS ARE FOR SPECIFIC LOCATIONS OF INDICATED FIXTURES WITHIN A CLUSTER.

17. ALL WALL MOUNTED ELECTRICAL RACEWAY IS SHOWN FOR COORDINATION ONLY. REFER TO ELECTRICAL DRAWINGS FOR THIS WORK.

18. LABORATORY FIXTURES & ACCESSORIES ARE SHOWN IN PLAN & ELEVATION FOR CASEWORK LOCATION AND CLEARANCES ONLY. SEE DETAILS IN LF1 SERIES DRAWINGS FOR SPECIFIC CONFIGURATIONS.

19. ALL COUNTER TOPS TO BE 30" DEEP, U.N.O.

20. TOP OF ALL COUNTER TOPS TO BE AT 34" A.F.F., U.N.O. BASE CABINET HEIGHTS LISTED IN CASEWORK SCHEDULE AND CASEWORK CATEGORY KEY ARE A GENERALIZATION. CONTRACTOR TO COORDINATE ACTUAL BASE CABINET DIMENSIONS WITH CASEWORK PRODUCT DATA, LAB TOP PRODUCT DATA, AND FIELD MEASUREMENTS OF EXISTING CONDITIONS.

21. LABORATORY CASEWORK TO BE WOOD, U.N.O.

22. ALL A/V CABINETS TO BE LOCKABLE. REFER TO ELEVATIONS OF LABORATORY CASEWORK FOR OTHER LOCATIONS OF LOCKABLE CABINETS.

23. PROVIDE CEILING ENCLOSURE TRIM BETWEEN THE TOP OF HOOD AND CEILING AT ALL FUME HOODS, PAINT TO MATCH WALL. SEE INTERIOR FINISH 2 | 07/25/2023 | ISSUE FOR BID, PERMIT

1 | 05/17/2023 | ISSUE FOR 50% CD

NO. DATE REVISIONS/ISSUANCES & DESIGN


CITY COLLEGES OF CHICAGO - TRUMAN COLLEGE

PROJECT NUMBER: PROJECT MANAGER: ARCH/ENG: L. GABEL SCALE: 1/4" = 1'-0" DRAWN BY: D. PORTH **CHECKED BY:** K. BOYER

LABORATORY SYMBOLS & SCHEDULES

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2 07/25/2023 ISSUE FOR BID, PERMIT 1 05/17/2023 ISSUE FOR 50% CD NO. DATE REVISIONS/ISSUANCES ARCHITECTURE & DESIGN

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- TRUMAN COLLEGE PROJECT NUMBER:

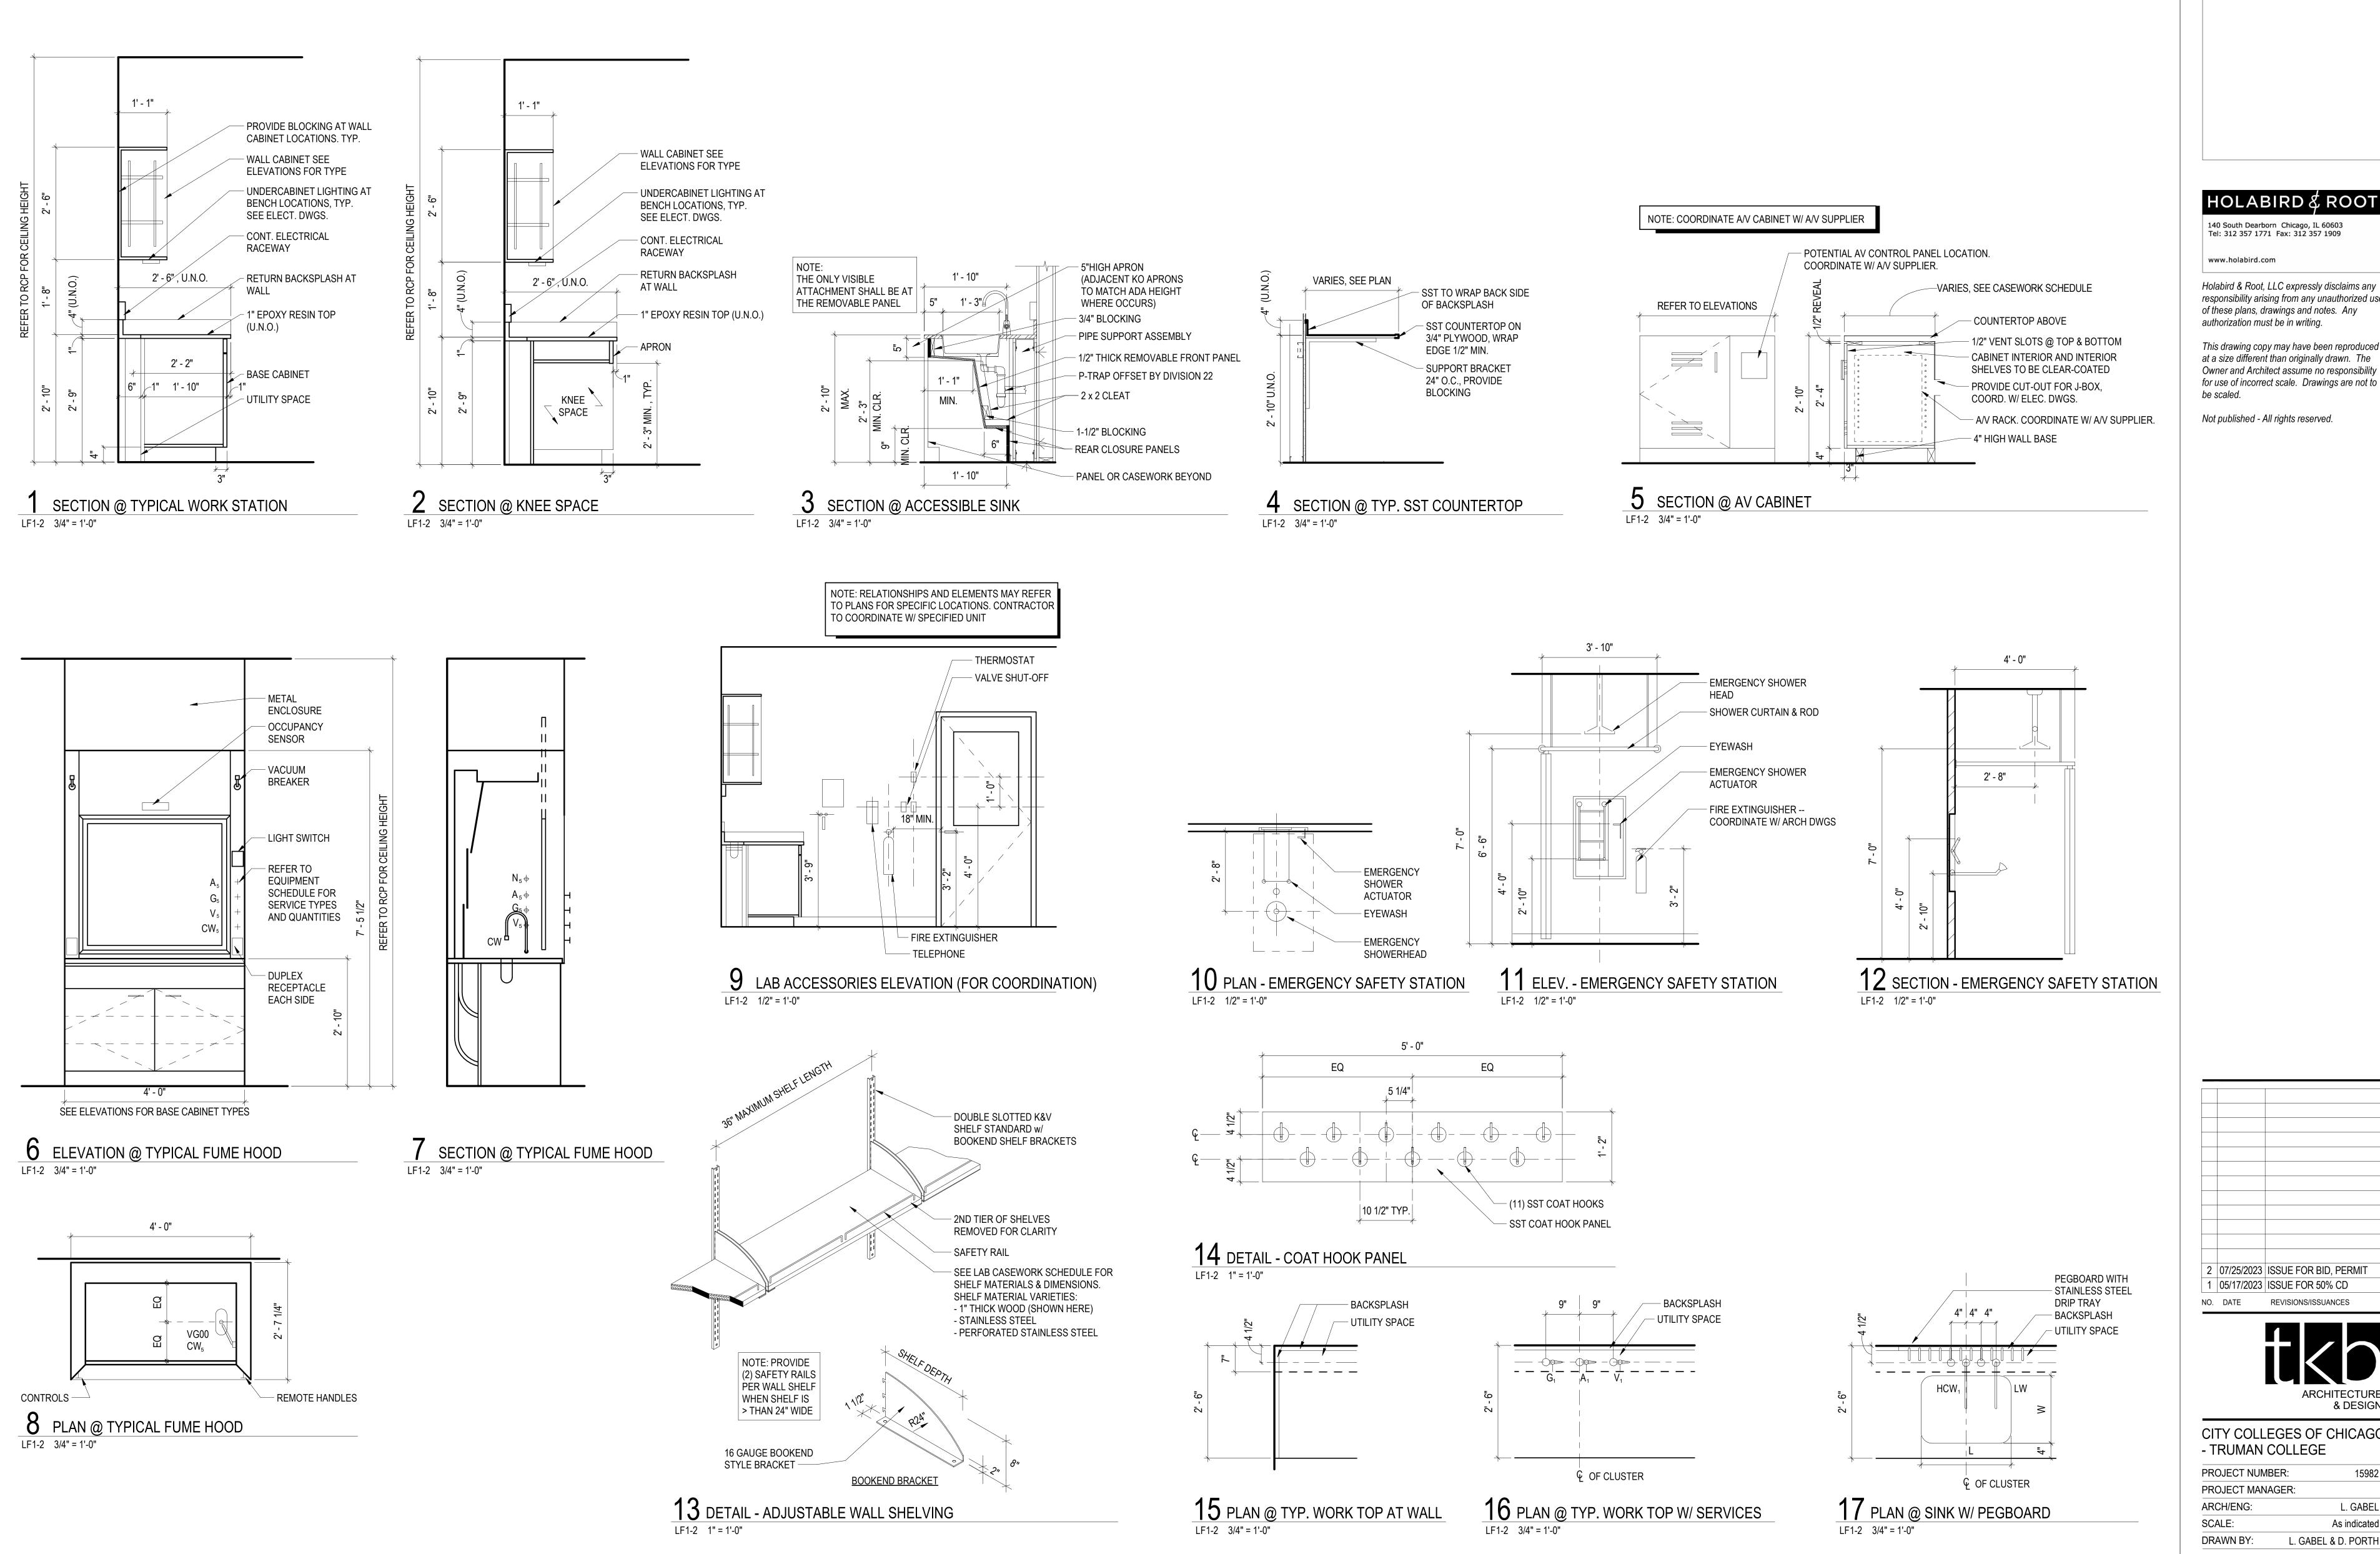PROJECT MANAGER: L. GABEL ARCH/ENG: SCALE: As indicated DRAWN BY: L. GABEL & D. PORTH K. BOYER CHECKED BY:

LABORATORY CASEWORK & EQUIPMENT DETAILS

Environmental Engineer MEPFP Engineer Architect of Record Structural Engineer Owner Harry S Truman
Education that Works Tilton Kelly + Bell, LLC 55 West Monroe - Suite 1975 Harry S Truman College Environmental Design International, Inc. 33 E Monroe Street #1825 E Wacker Dr #303 1145 W Wilson Ave, Chicago, IL 60603 Chicago, IL 60603 Chicago, IL 60601 Chicago, IL 60604

(773) 907-4000


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312.447.3100


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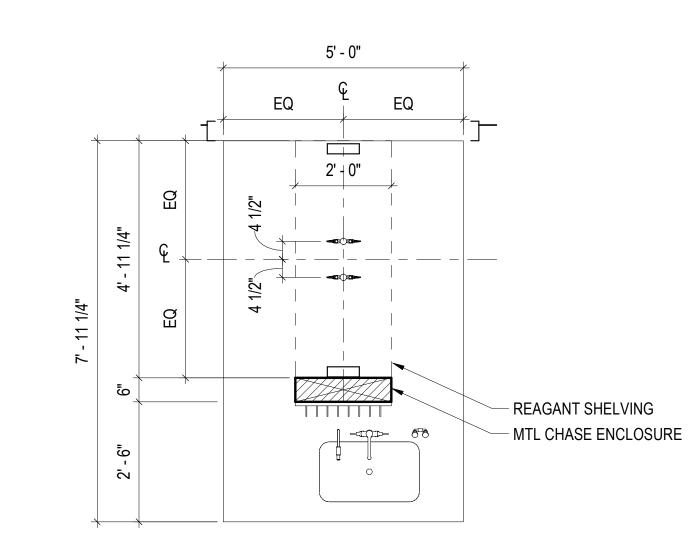
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SECTION @ TYPICAL ISLAND BENCH / REAGENT SHELVING LF1-3 3/4" = 1'-0"






18 ENLARGED GENERAL BIOLOGY PREP BENCH

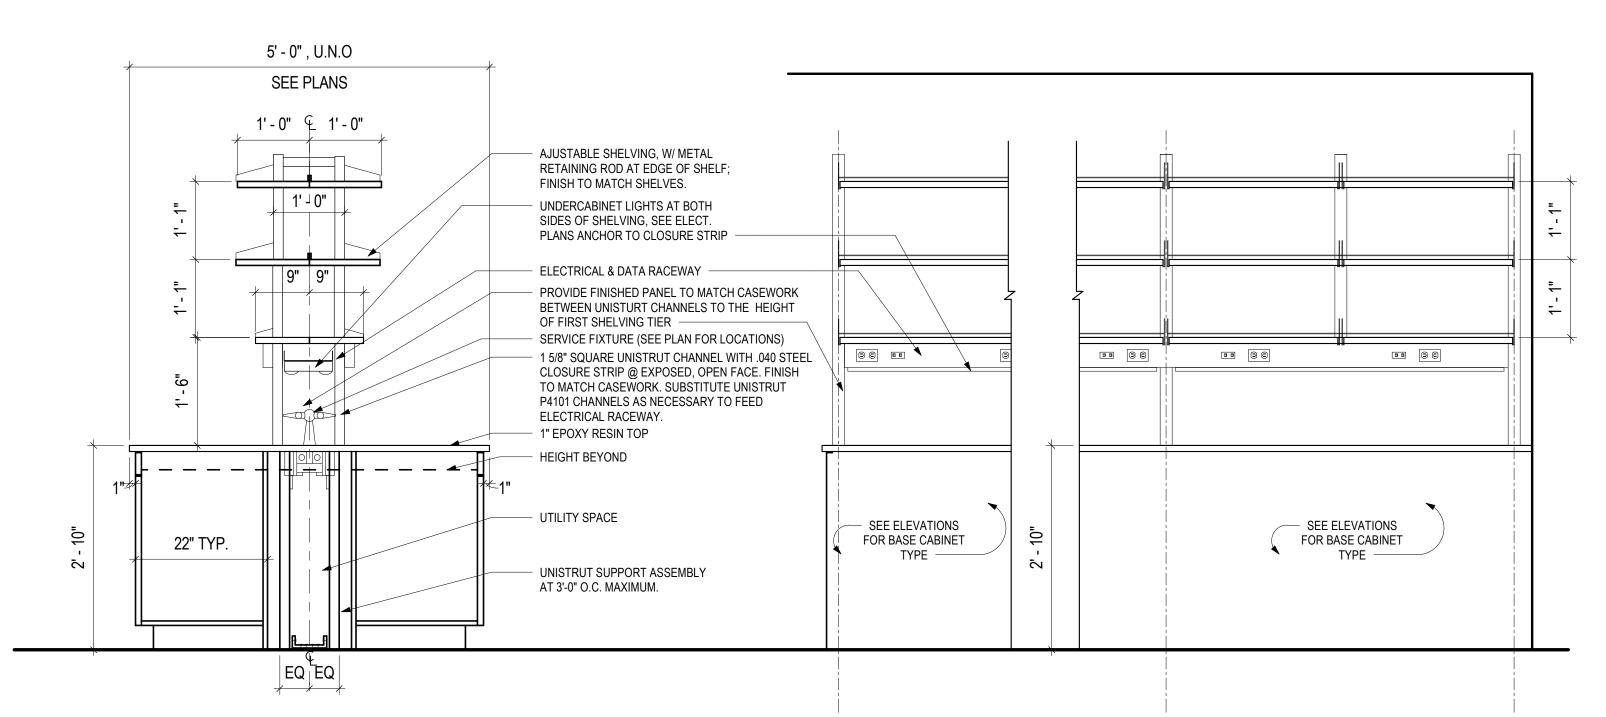LF1-3 1/2" = 1'-0"

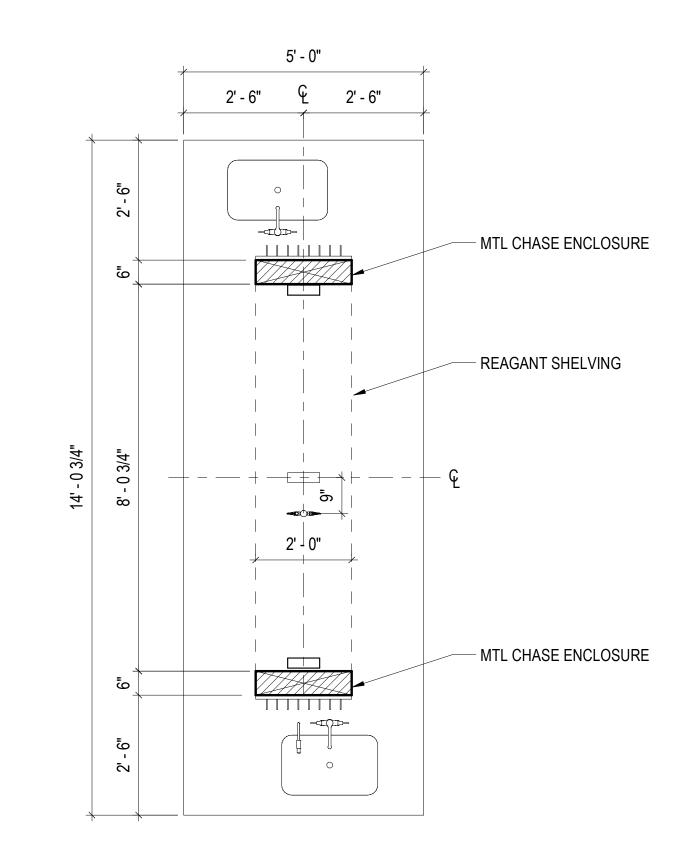19 ENLARGED MICROBIOLOGY PREP BENCH
LF1-3 1/2" = 1'-0"

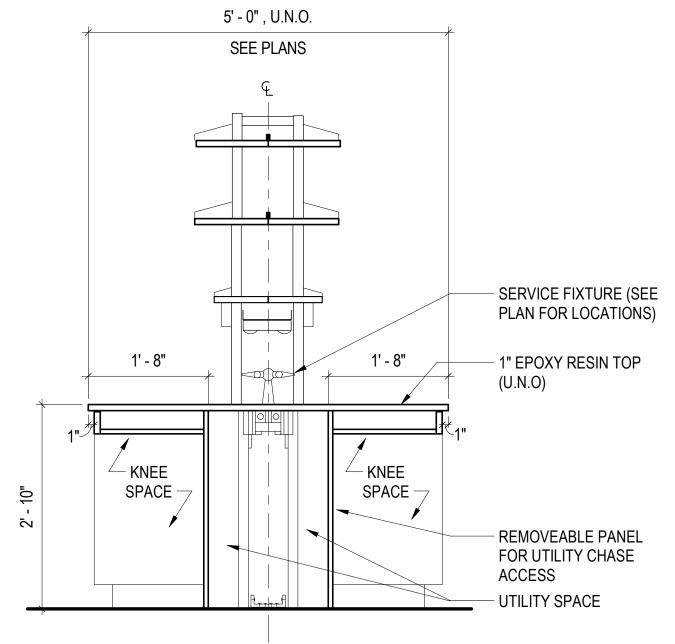

2 SECTION @ ISLAND BENCH KNEE SPACE LF1-3 3/4" = 1'-0"

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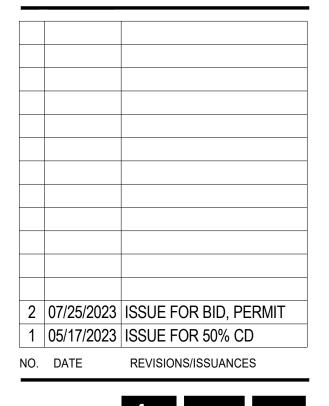
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PROJECT NUMBER: PROJECT MANAGER: ARCH/ENG: L. GABEL SCALE: As indicated DRAWN BY: L. GABEL & D. PORTH CHECKED BY: K. BOYER

LABORATORY CASEWORK & EQUIPMENT DETAILS

Structural Engineer Environmental Engineer MEPFP Engineer

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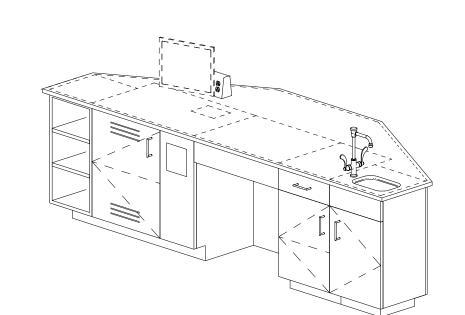
Architect of Record Tilton Kelly + Bell, LLC 55 West Monroe - Suite 1975 Chicago, IL 60603 312.447.3100 www.tiltonkellybell.com

Owner Harry S Truman College 1145 W Wilson Ave, Chicago, IL 60604 (773) 907-4000 www.ccc.edu




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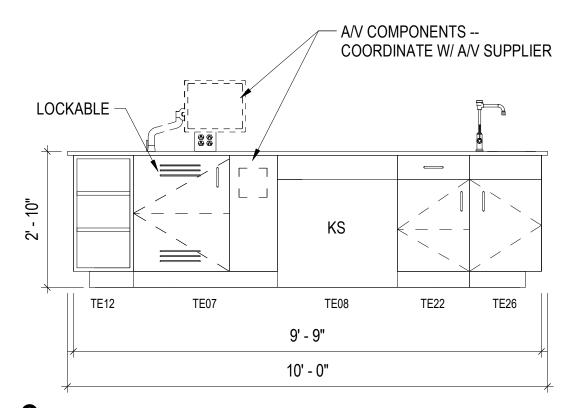
ARCHITECTURE & DESIGN




A&P TEACHING ISLAND - FRONT LF1-4

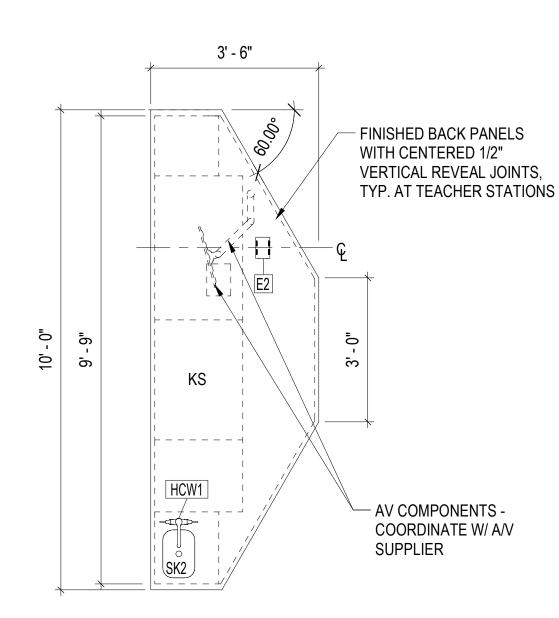


2 ENLARGED A&P TEACHER STATION LF1-4 1/2" = 1'-0"




3 A&P TEACHER STATION - FRONT LF1-4 1/2" = 1'-0"

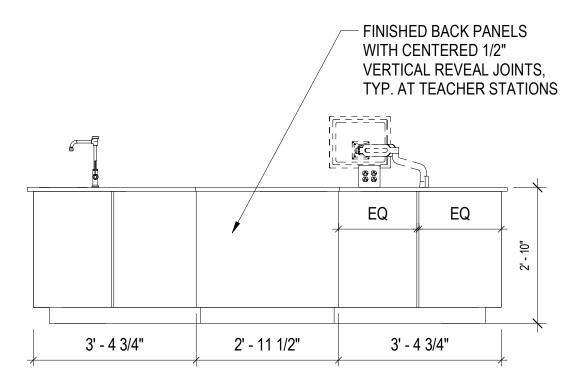


4 A&P TEACHER STATION - BACK LF1-4 1/2" = 1'-0"

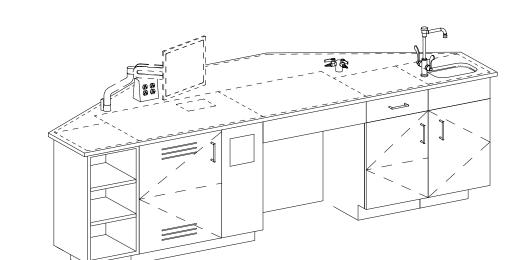


**5** MIRCOBIOLOGY TEACHER STATION - FRONT LF1-4

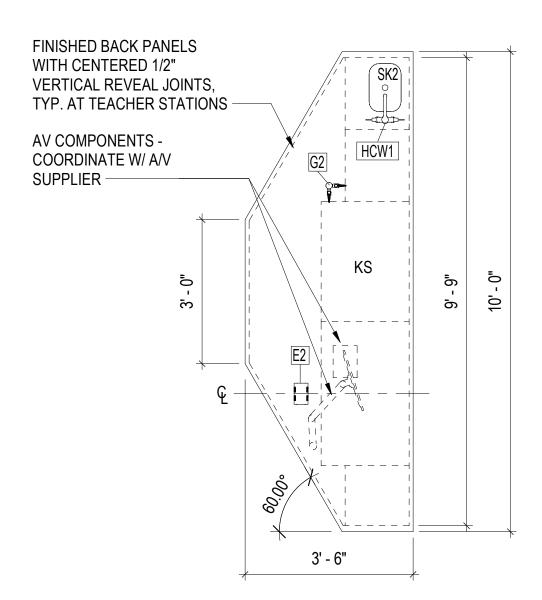


6 ENLARGED MICROBIOLOGY TEACHER STATION LF1-4 1/2" = 1'-0"

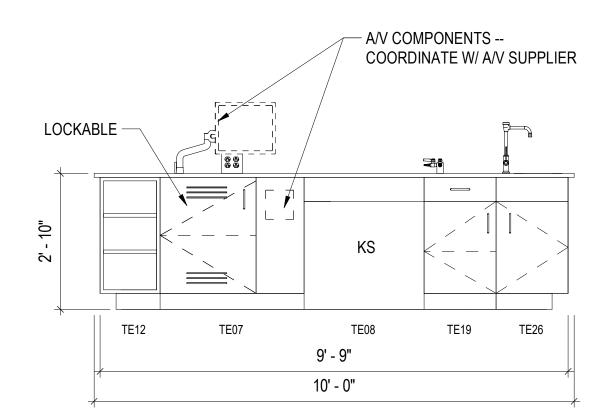


MICROBIO TEACHER STATION - FRONT LF1-4 1/2" = 1'-0"

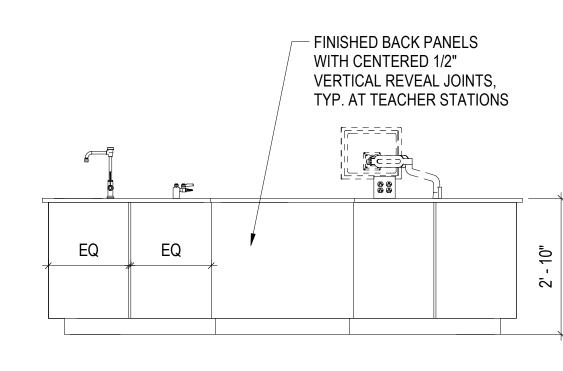


8 MICROBIO TEACHER STATION - BACK LF1-4 1/2" = 1'-0"

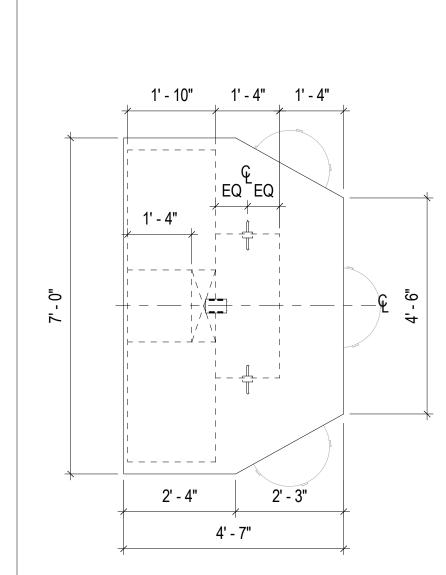


11 ENLARGED A&P STUDENT STATION CASEWORK DIMENSIONS LF1-4 1/2" = 1'-0"

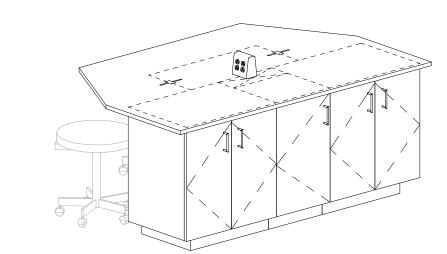


9 A&P STUDENT STATION - FRONT

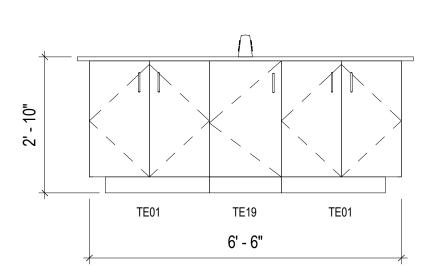

12 A&P STUDENT STATION - FRONT LF1-4 1/2" = 1'-0"

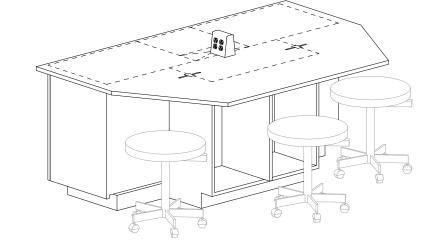


10 A&P STUDENT STATION - BACK

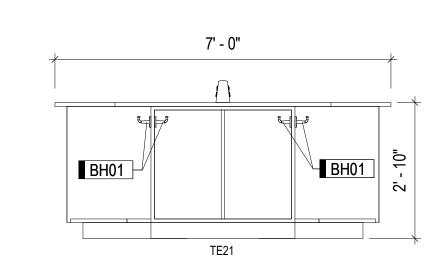


13 A&P STUDENT STATION - BACK


LF1-4 1/2" = 1'-0"

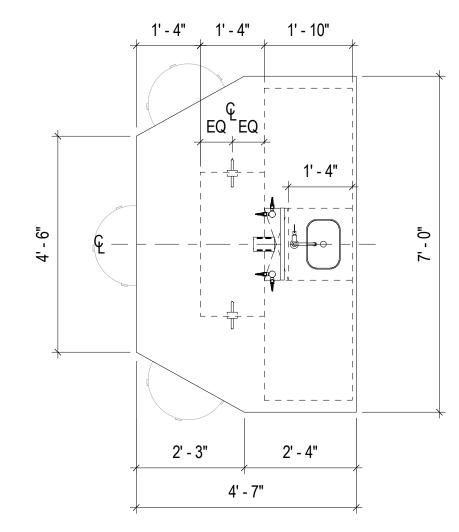


16 ENLARGED MICROBIO STUDENT STATION CASEWORK DIMENSIONS LF1-4 1/2" = 1'-0"

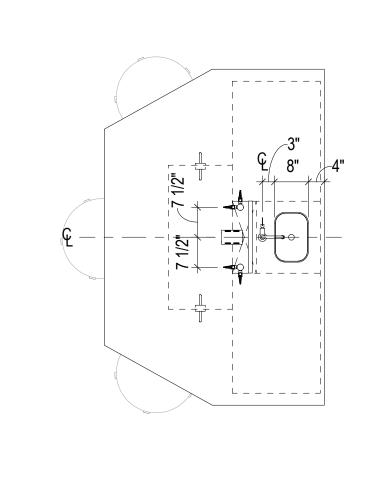


17 ENLARGED MICROBIO STUDENT STATION EQUIPMENT DIMENSIONS LF1-4 1/2" = 1'-0"

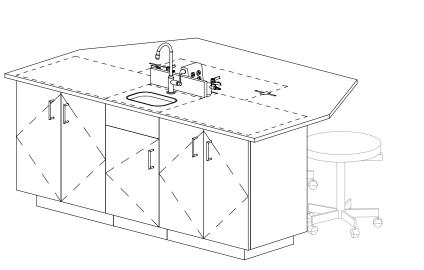


14 MICROBIO STUDENT STATION - FRONT

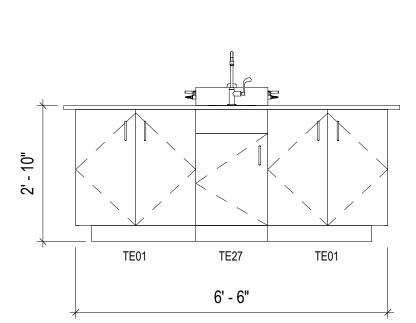


18 MICROBIO STUDENT STATION - FRONT
LF1-4 1/2" = 1'-0"

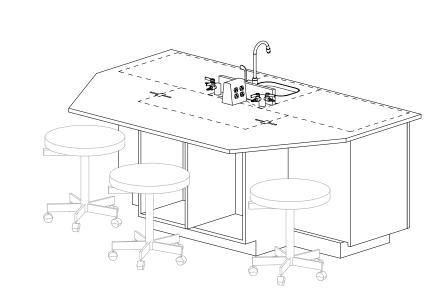

15 MICROBIO STUDENT STATION - BACK

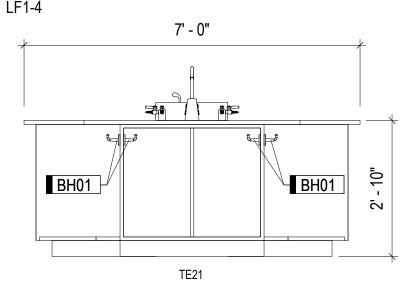

19 MICROBIO STUDENT STATION - BACK LF1-4 1/2" = 1'-0"

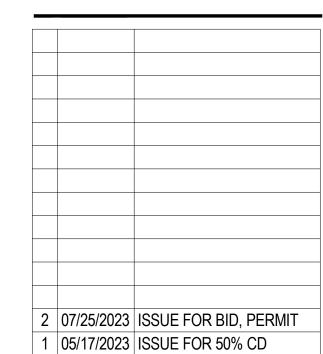

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CITY COLLEGES OF CHICAGO - TRUMAN COLLEGE

PROJECT NUMB	ER: 15982
PROJECT MANA	GER:
ARCH/ENG:	L. GABEL
SCALE:	1/2" = 1'-0'
DRAWN BY:	L. GABEL & D. PORTH
CHECKED BY:	K. BOYER

LABORATORY CASEWORK & EQUIPMENT DETAILS

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Architect of Record

Owner

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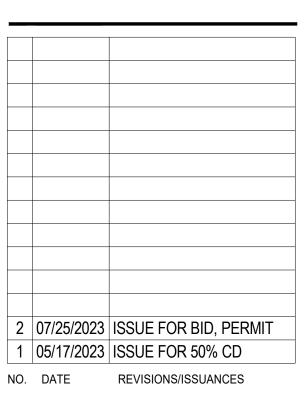
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SCALE: As indicated DRAWN BY: L. GABEL & D. PORTH CHECKED BY: K. BOYER

LABORATORY FURNISHINGS PLAN

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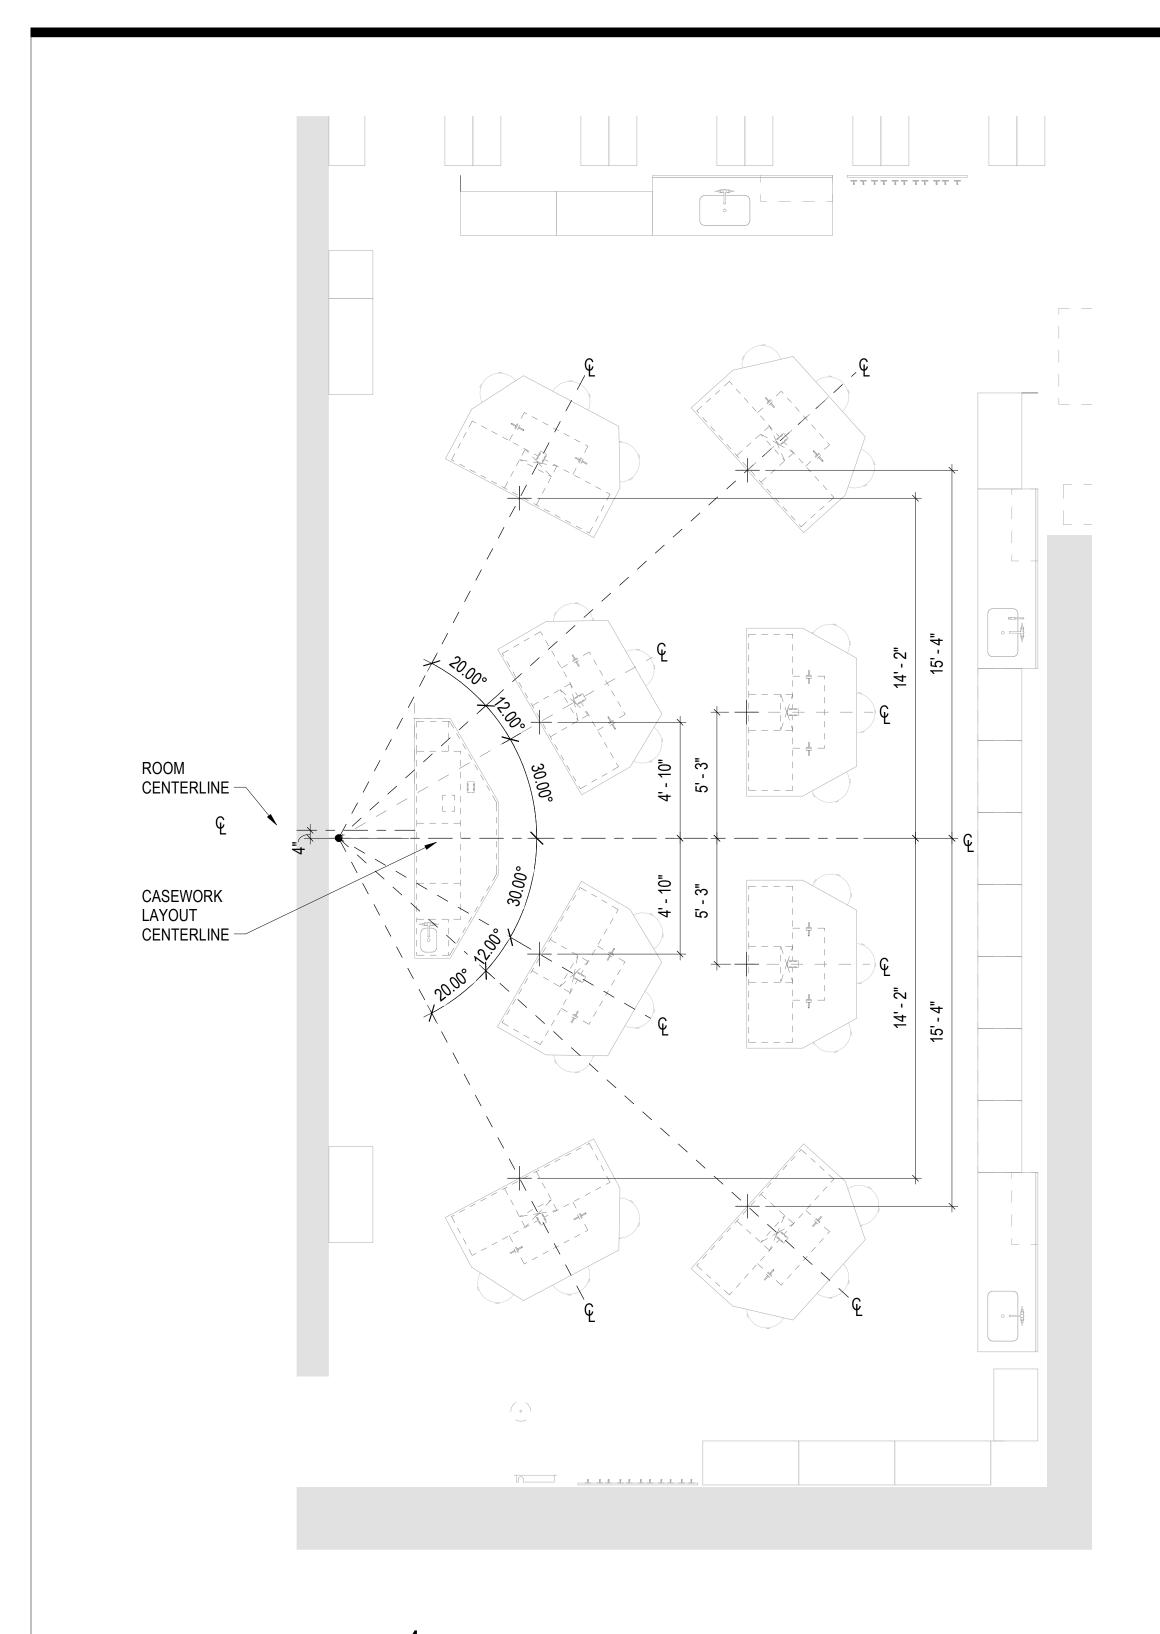
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Chicago, IL 60604


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1 DIMENSION PLAN - A&P LAB

LF2-2 1/4" = 1'-0"



2 DIMENSION PLAN - MICROBIOLOGY LAB

LF2-2 1/4" = 1'-0"
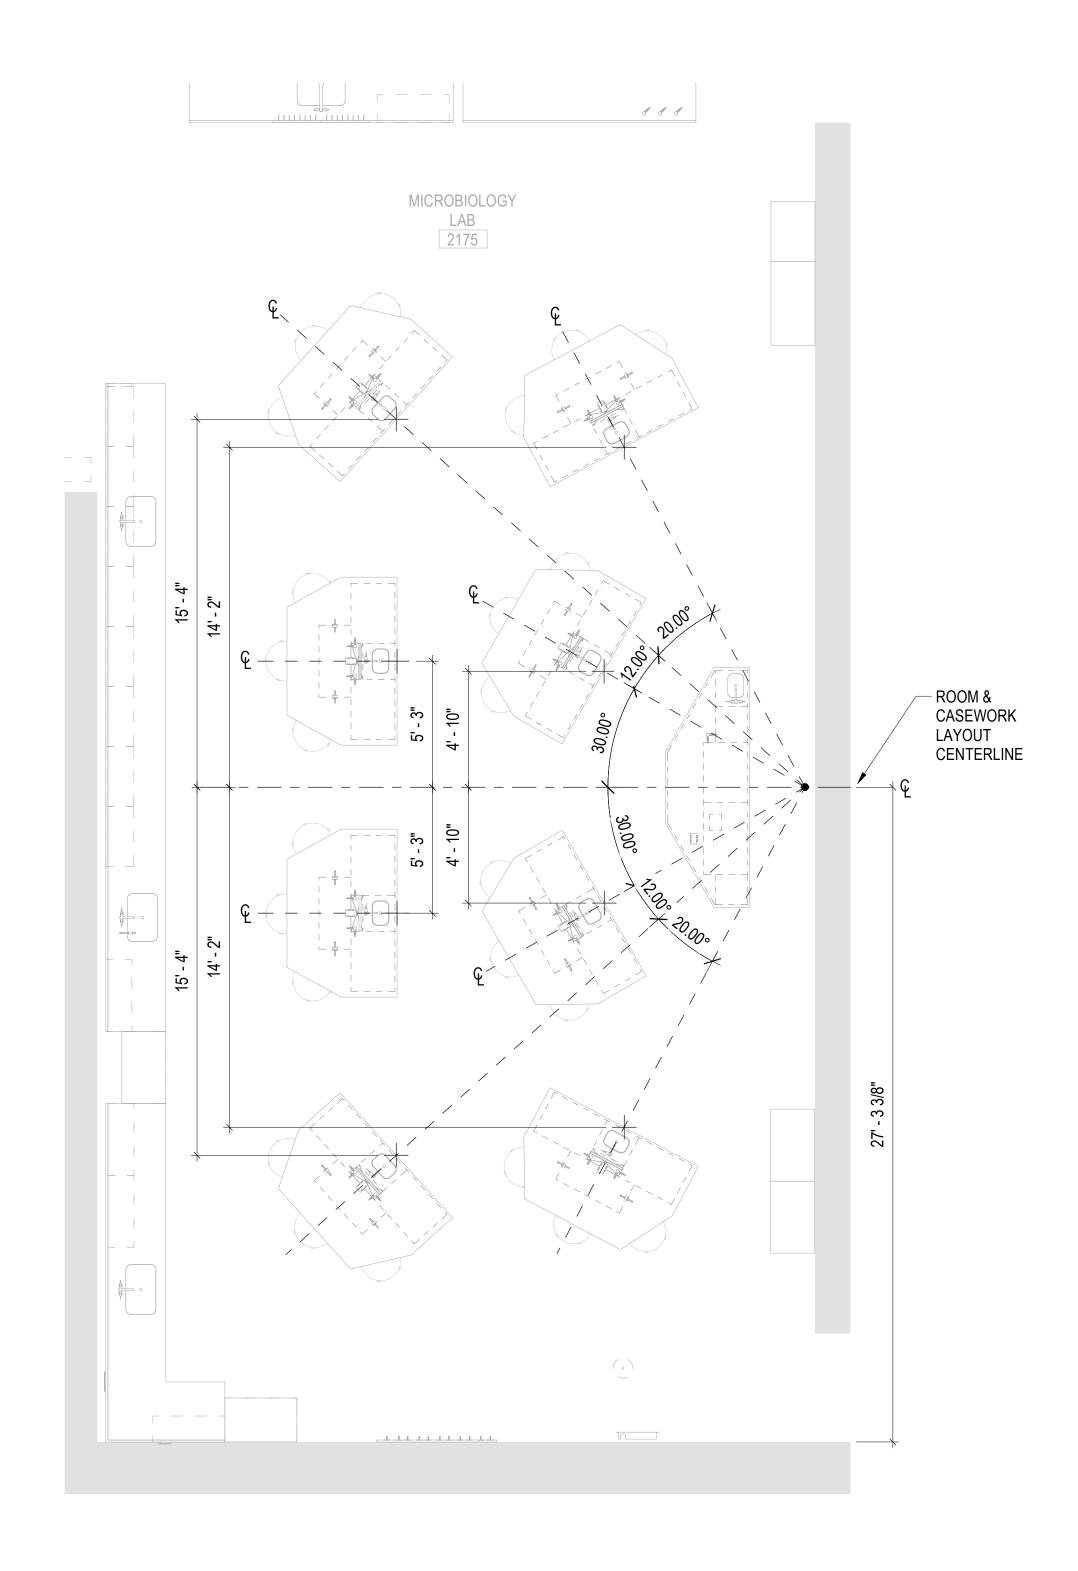
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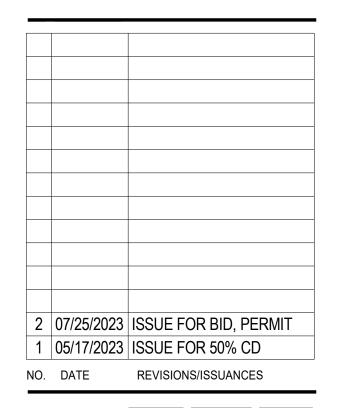
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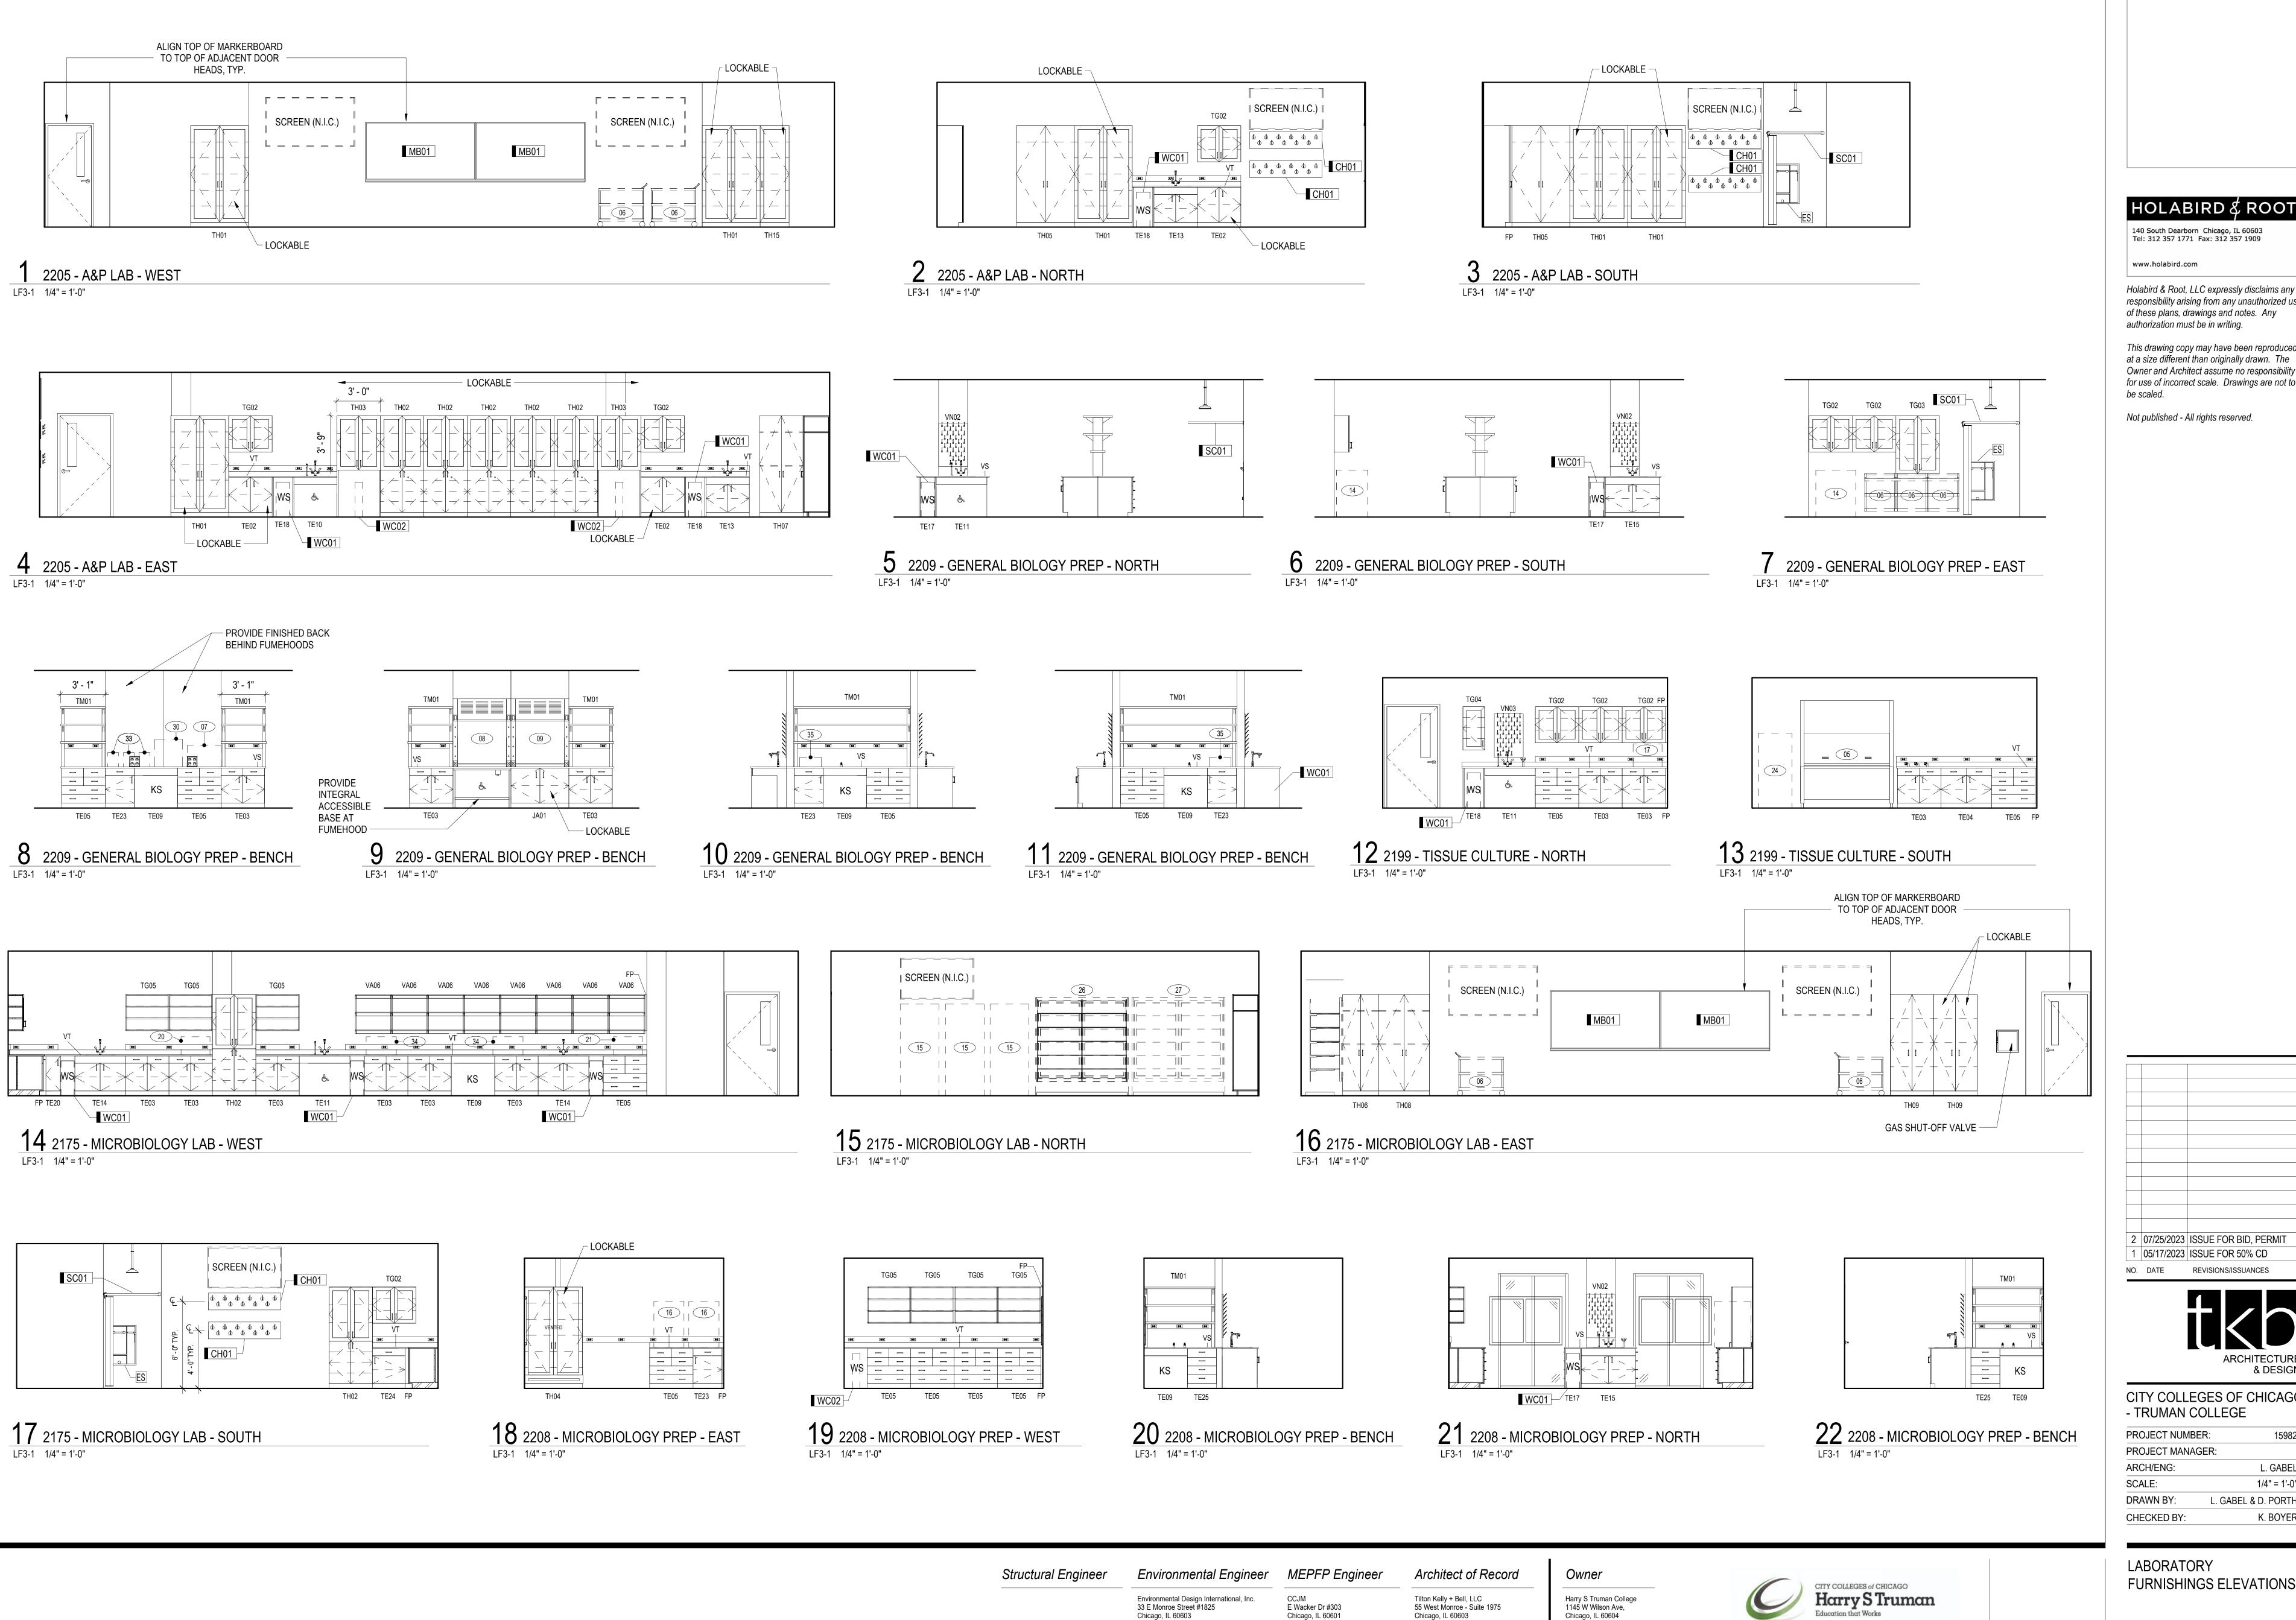
LABORATORY FURNISHINGS DIMENSION PLAN

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ARCHITECTURE & DESIGN

CITY COLLEGES OF CHICAGO - TRUMAN COLLEGE

PROJECT NUMBER: PROJECT MANAGER: ARCH/ENG: L. GABEL SCALE: 1/4" = 1'-0" L. GABEL & D. PORTH DRAWN BY:

LABORATORY **FURNISHINGS ELEVATIONS** 

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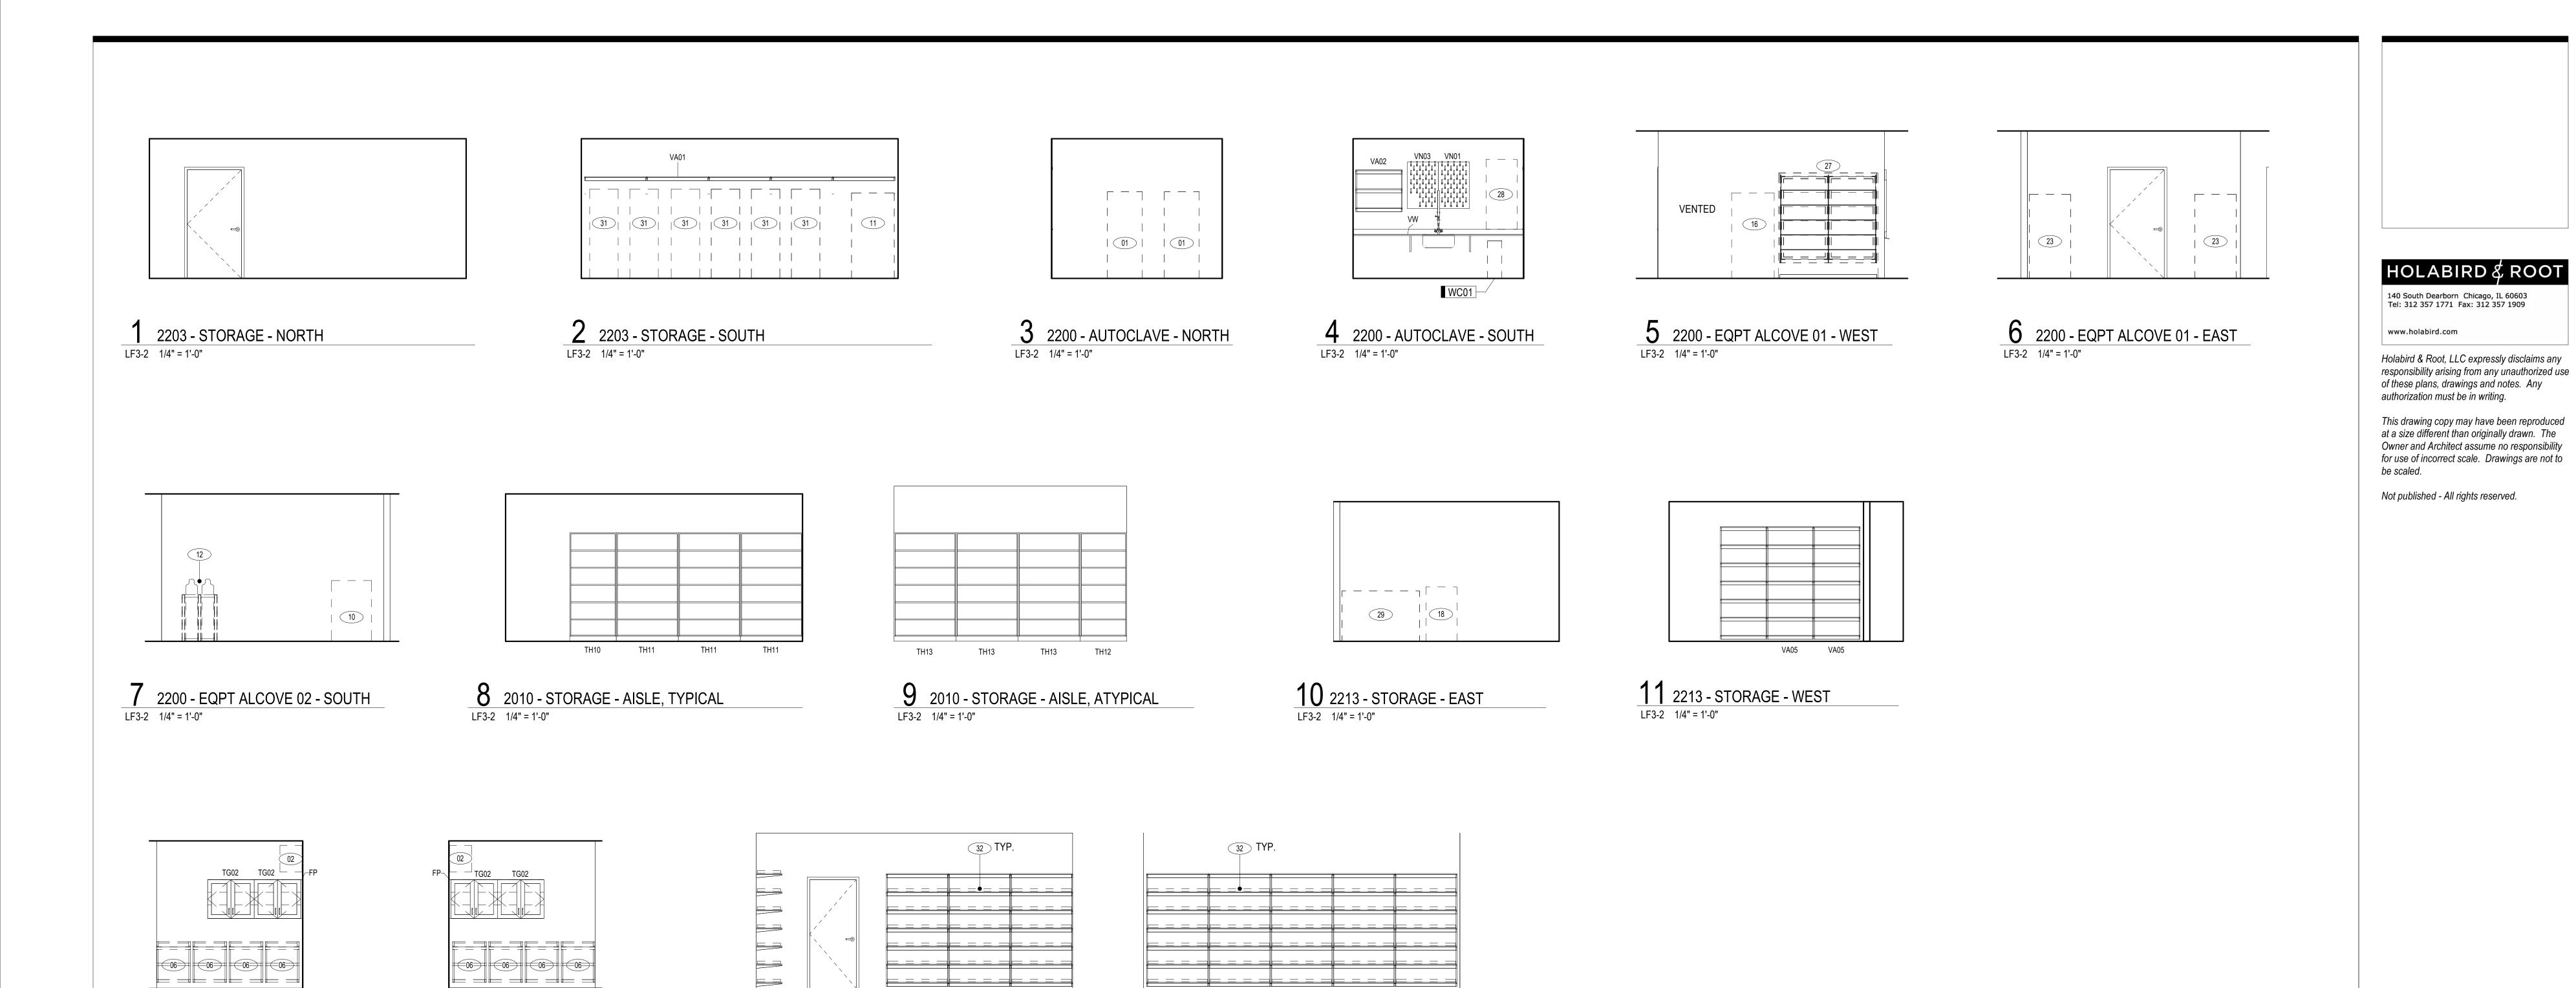
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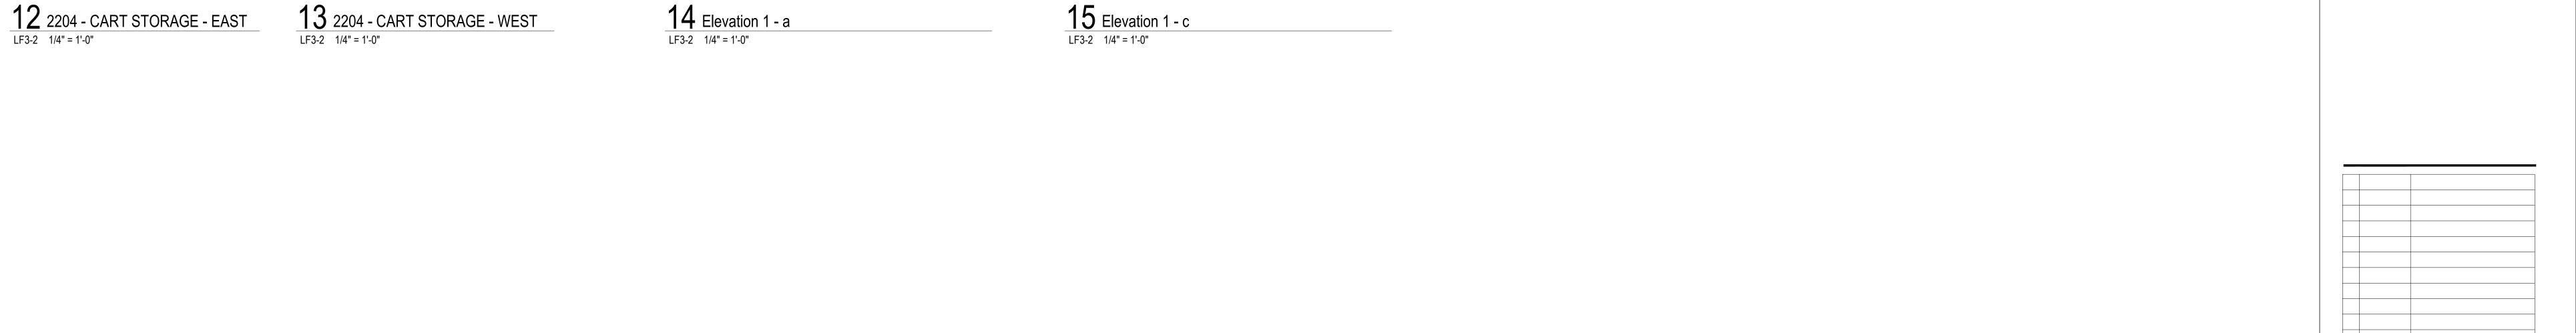
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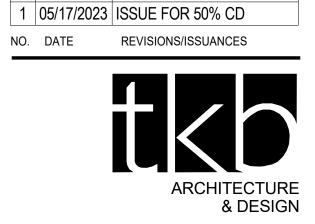
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- IRUMAN C	OLLEGE
PROJECT NUMB	ER: 1598
PROJECT MANAG	GER:
ARCH/ENG:	L. GABEI
SCALE:	1/4" = 1'-0
DRAWN BY:	L. GABEL & D. PORTH
CHECKED BY:	K. BOYEF

LABORATORY

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